

ADDENDUM NO. 1
TO THE
DRAWINGS AND SPECIFICATIONS
FOR THE
17TH Street Reconstruction

Issued From: The City of Bloomington
Planning and Transportation Department
Post Office Box 100
401 North Morton Street, Suite #130
Bloomington, Indiana 47402

Issue Date: January 24th, 2019

Letting Date: January 29th, 2019

This Addendum No. 1 to the drawings and specifications shall supplement, amend and become a part of the Bid documents, plans, and specifications for the 17th Street Reconstruction. All Bids and construction contracts shall be based on these modifications to the original contract documents. Bidders shall acknowledge receipt of this Addendum on the Bid Form. Failure to do so may subject the Bidder to disqualification.

Item No. 1: Street Name Signs

The City of Bloomington Standard Traffic Street Name Sign Details, Standard Drawing No. – SS-1 dated 8/21/2018, is attached with this Addendum. The provided standard drawing shall be the basis for the shop drawing development of the proposed street signs and shall override the details as shown on sheets 43 & 44 of the plans. Shop drawings for the proposed street signs shall be submitted to the city for review and approval prior to manufacturing. Revised Plan sheets 43 & 44 have been added per this addendum.

Item No. 2: Right of Entry

The City of Bloomington would like to remind all bidders of INDOT Standard Specification 107.14 which prohibits entering private property for any propose without first obtaining proper permission. There are currently Rights of Entry in place for the following parcels: Victoria Starkey Temple (Parcel 7), Jon B. Bowman (Parcel 10) and Leonard D. Smith (Parcel 14).

The city would like to emphasize that this includes using private drives for turning around and unloading of construction materials/equipment. The two entrances to the property located at 1800 W 17th St. shall have mounted signs with the following message: "NO CONSTRUCTION TRAFFIC BEYOND THIS POINT". The signs shall be 60"x30" with the text sized and spaced to fill the sign area. The Contractor shall submit a shop drawing of the sign layout for review and approval prior to manufacturing and installation. No direct payment will be made for the signs or their installation, the work shall be included in the item "Maintaining Traffic".

Item No. 3: Neighborhood Sign

The "Relocated Sign" referenced on the Landscape Details, plan sheet 59, is to be relocated from its current location at 1319 N Crescent Rd. Bloomington, IN 47404. The sign is a solid limestone block that is 9' long x 2' wide x 4'-8" tall with an approximate weight of 6.5 tons. The sign shall be placed upon a sign foundation that is detailed on plan sheet 41-1, which is attached to this Addendum. The sign shall be oriented as shown on the plans with the sign lettering facing westbound traffic.

Payment for "Relocate Neighborhood Sign" shall be at the contract unit price per lump sum, which shall include all labor, materials, equipment, excavation and any incidentals required for the sign foundation and sign relocation. Plan sheet 41-1 and a revised "Proposal Schedule of Items" have been added per this addendum.

Item No. 4: Concrete Sidewalk Removal

As a clarification to the plans the existing sidewalk within the project limits along 17th St. is to be removed. The removal quantity is as quantified on the "Proposal Schedule of Items" in the bid documents.

Item No. 5: Crosswalk Lines

The Pavement Marking & Signing Details, sheets 42 and 75, have been revised to call out 24 inch Crosswalk lines at Arlington Park Drive. Revised plan sheets 42 & 75 and a revised "Proposal Schedule of Items" have been added per this addendum.

Item No. 6: Tree Clearing Schedule

To facilitate utility relocation work for the project, tree clearing operations shall commence within one (1) week after issuance of the Notice to Proceed and shall be completed within 30 days.

Item No. 7: Staking Right-of-Way Limits

To facilitate utility relocation work for the project the permanent Right of Way limits shall be staked throughout the project extents. The Right of Way staking shall be marked to identify the permanent Right of Way and include the roadway centerline stationing. Since the utility work is critical path the staking shall be completed within three days after the completion of the tree clearing.

No direct payment will be made for this work, but the cost thereof shall be included in the item "Construction Engineering".

Item No. 8: Light Pole Foundations

Duke Energy's design team has now recommended that direct buried poles be utilized on this project. Duke Energy will be furnishing and installing the direct buried pole. Therefore, Light Pole Foundations have been deleted on Sheets 46-49 as well as the detail on sheets 54. Revised Plan sheets 46-49, and 54, and a revised "Proposal Schedule of Items" have been added per this addendum.

Item No. 9: Tree Removal

The Tree Removal Details, sheets 68 & 69, have been revised. Revised plan sheets and a revised "Proposal Schedule of Items" have been added per this addendum.

Item No. 10: Landscape Plans

The Landscape Details, sheets 55 thru 59, have been revised. Revised plan sheets 55-59 and a revised "Proposal Schedule of Items" have been added per this addendum.

Item No. 11: Storm Sewer

The Pipe material for Storm Sewer Structure Nos. 62, 70 and 71 shall be C-900 pipe. The cost of the pipe shall be paid for under the item "Pipe, Type 2, Circular, 12 In." per the "Proposal Schedule of Items".

The Plan and Profile Details, sheets 17 & 18, and the Structure Data Table, Sheet 77, have been revised to add separate structures for the Aqua-Swirl structures at the east end of the project. Revised plan sheets and a revised "Proposal Schedule of Items" have been added per this addendum.

Item No. 12: Fiber Optic and Lighting Conduits

All conduit ends, not within a manhole or handhole structure, shall be capped with a removable cap and shall remain capped. The inside surface of the conduit shall be kept clean. Conduit to be installed as indicated on the plans for future use of the utility company. The conduits shall be left in place with a pull cord on its entire length. No direct payment will be made for this work, but the cost thereof shall be included in the cost of the conduits.

Item No. 13: Material Testing

The Contractor shall be responsible for securing and paying for outside material testing as set out in Special Provisions Section 02 Part 1.01A of the Contract Documents. Special Provisions Section 02 Part 1.01B of the Contract Documents shall be deleted, the testing requirements and frequency of tests shall in accordance with the INDOT Frequency Manual.

Item No. 14: Maintaining Traffic

The Contractor is advised that all local traffic is to be maintained at all times. In addition Bloomington Transit Route will need to be maintained at all times between Crescent Road and Lismore Drive. The west end of the 24 inch water main relocation falls within this segment of roadway. Therefore the Contractor shall prepare a maintenance of traffic plan for this area to submit for review and approval prior to commencing work on the waterline relocation. Any cost

associated with developing the plan, implementing and maintaining the Bloomington Transit Route will not be paid for separately but will be included in the lump sum cost of "Maintaining Traffic".

The project is set up for a full roadway closure. The Contractor is advised that a full closure will be allowed for tree clearing operations and then reopened until such time the roadway construction commences.

The item "Quality Adjustment, Temporary Traffic Control Devices" will be added to the contract. The quality adjustments shall be in accordance with INDOT Standard Specifications Section 109.05.1(c). The updated "Proposal Schedule of Items" has been added per this addendum.

Item No. 15: City of Bloomington Utilities (CBU)

The Contractor is advised that existing private water services and existing private sanitary sewer laterals that will remain under the wall shall have a split casing around the existing service lines from the retaining wall shear key to 15 feet to allow for future maintenance without disturbing the walls. Below is a summary of the locations:

- Wall No. 2 – Two (2) private water services and One (1) private sanitary sewer lateral
- Wall No. 3 – One (1) private water services and One (1) private sanitary sewer lateral
- Wall No. 4 – One (1) private water services and One (1) private sanitary sewer lateral
- Wall No. 5 – Two (2) private water services and One (1) private sanitary sewer lateral
- Wall No. 7 – One (1) private water services and One (1) private sanitary sewer lateral

The size of the split casing for the private water services shall be 4 inch and the size for the private sanitary sewer laterals shall be 12 inch. The items "Split Casing, 4 In." and "Split Casing, 12 In." will be added to the contract. The updated "Proposal Schedule of Items" has been added per this addendum.

CBU's GIS records indicate a sewer lateral wye for the property at 1604 W 17th Street is about 2' south of the existing manhole at Sta. 40+79 Line "SS-3". Since this section of sanitary sewer main is to be removed and replaced, the contractor will be required to install a new wye on the new main and reconnect the existing sanitary sewer lateral." The Utility Plan, sheets 48, has been revised to add notes for Wye. A revised plan sheet has been added per this addendum.

Item No. 16: Questions and Answers

(Q) How is the handrail to be mounted? What is it anchored to?

(A) Per the details shown on the drawings, the posts are field welded to a base plate which is cast into the "Cast in Place" coping.

(Q) The asphalt pay items and mix are QC/QA, this being said and INDOT specs being followed the contractor should have the opportunity for volumetric mix bonuses on the job. Those pay items are missing, will they be added?

(A) Yes, the item "Quality Adjustment, HMA" will be added to the contract. The quality adjustments shall be in accordance with INDOT Standard Specifications Section 109.05.1 and shall be computed in accordance with Section 401.19. The updated "Proposal Schedule of Items" has been added per this addendum.

(Q) The project doesn't meet the speed design requirements for profilograph, will it be deleted?

(A) Yes, the item Profilograph will be deleted. However, the Contractor will be required to provide a 16 ft straightedge and 10 ft straightedge. The straightedge testing shall be in accordance with INDOT Standard Specifications Section 401.18(b). The updated "Proposal Schedule of Items" has been added per this addendum.

(Q) Can you please provide an update on utility re-location progress?

(A) Yes, the latest utility relocations plans have been posted on BloomingBid by the City of Bloomington.

(Q) With Duke not completing re-location per the specs until June 15th and others to follow after them it is possible work could not begin until sometime in July. However the spec reads we have 215 calendar days to complete the project after notice to proceed. This is not possible to do, can you please re-visit the completion date? Possibly do half the project this season and half next.

(A) No, The project is to be completed within the specified number of calendar days. A notice to proceed is anticipated to be issued in early February after the project has been awarded. The early notice to proceed will be for activities such as tree clearing and Right-of-Way staking to expedite utility relocations. The official calendar day count will not commence until April 1, 2019. Roadway work and Contractor installed utility work shall occur simultaneous with Utility Company relocation activities. Work activities on waterline relocation, force main, sanitary and storm sewer installation, excavation and retaining wall work shall occur concurrently with the outside utility relocations.

(Q) Would you consider adding the pay item, "temporary #53 stone for driveway maintenance"?

(A) No, it is to be included in the item "Maintaining Traffic".

(Q) Will the rock excavation pay item be paid for rock in utility / storm trenches or is it to be included in the utility?

(A) The item "Excavation, Rock" has been revised to be an undistributed quantity of 375 CYS. This undistributed quantity is to be utilized where rock is encountered on the project including utility / storm trenches. Pay limits for rock excavation shall be in accordance with CBU Construction Specifications section 4.5.1.2.1.2.4.

(Q) Will testing of the new sanitary manholes that get installed on live lines be waived?

(A) No, CBU will require testing.

(Q) Does the city have any flow data they could share on the 12" and 8" sanitary that get relocated (for bypass pumping calculations)?

(A) No, bypass pumps shall be sized based upon the pipes flowing full.

(Q) Can you please provide an update on R/W acquisition for Glick Arlington?

(A) The Glick Arlington Park parcel is still in negotiations. It anticipated that it will be cleared within the next month.

(Q) A bid price for item #17 should be provided by the owner/engineer?

(A) The bid price has been added. The updated "Proposal Schedule of Items" has been added per this addendum.

(Q) Does the rebar item pay for all rebar in footings, walls and coping? If not what is paid as rebar and what isn't?

(A) Yes. The rebar pay item pays for all rebar in the footing, wall and coping.

(Q) What are the pay limits for concrete B footing?

(A) Pay limits for Concrete B are the entire concrete footing, including the turn down (shear key) and the pedestal.

(Q) Cover height seems to be concern on the 24" valves, can you please specify if a beveled tap valve will be required?

(A) CBU will make a field determination once the existing main has been exposed, for bidding purposes the Contractor shall assume that the beveled tap valve will be required.

(Q) Will the 24" hot taps/valves need to be inside manholes?

(A) No manholes are not required, the valves are required to be in a valve box.

(Q) Will the surface pavement be placed by the city or by the contractor?

(A) The Contractor will be responsible for placement of the surface course.

(Q) Will the city consider changing intermediate and surface asphalt courses to 2, 64 from 2, 70 type mix?

(A) Yes, the Legend Item K, sheets 2-6 have been revised. The surface and intermediate layers shall be 2, 64 type mix. Revised plan sheets and a revised "Proposal Schedule of Items" have been added per this addendum.

(Q) Is a field office being required for the project?

(A) Yes, it is item 57 on the "Proposal Schedule of Items".

(Q) Some of the aqua-swirls are shown with more than one inlet. After talking with manufacturer this cannot be accomplished, there should be one inlet and one outlet?

(A) The Plan and Profile Details, sheets 17 & 18, and the Structure Data Table, Sheet 77, have been revised to add separate structures for the Aqua-Swirl structures at the east end of the project. Revised plan sheets and a revised "Proposal Schedule of Items" have been added per this addendum.

(Q) Are the gate valve items to pay for Valves as indicated, or Tapping Valves and Tap?

(A) Gate tapping valves and tap. The Utility Details, sheets 52 & 53, have been revised to clarify the type of valves required. Revised plan sheets and a revised "Proposal Schedule of Items" have been added per this addendum.

(Q) Should the 24" gate valve be butterfly instead of Gate?

(A) Per discussions with CBU, a 24" gate tapping valve is required.

(Q) Are the 6" gate valves for the fire hydrants?

(A) Yes, see City of Bloomington Standard Detail Number 8.

(Q) Will you be creating an item for 6" tap valve?

(A) Yes, the item "Gate Tapping Valve, Ductile Iron, 6 In." will be added to the contract. The updated "Proposal Schedule of Items" has been added per this addendum.

(Q) What, if any materials will be provided by the city for the new water services?

(A) Per CBU Construction Specifications section 4.5.3.7, domestic meters, service yokes and pits shall be purchased from CBU. The Contractor shall submit a reimbursement request for the exact amount without any mark-up to the City of Bloomington.

(Q) How are the old water services to be abandoned? Or do we re-connect to existing line for the new services?

(A) Re-connection to the existing lines for new service at the proposed metered locations. Meter locations are approximate and field verification of the existing service lines shall be required.

(Q) Is poly acceptable material for the service lines?

(A) Blue polyethylene is acceptable, see CBU Construction Specifications sections 4.4.4.1.4. & 4.4.4.1.4.1.

(Q) Can you please identify what the excavation X item is paying for?

(A) Excavation X is for structural excavation for the retaining walls.

(Q) Will a topsoil item be created to pay for imported topsoil?

(A) Yes, the item "Topsoil" will be added to the contract. The updated "Proposal Schedule of Items" has been added per this addendum.

- (Q) Is the structure backfill item to pay for only storm backfill or sanitary and water as well?
- (A) The item "Structural Backfill, Type 1" is only for the storm sewer pipe. The backfill for the sanitary sewer and water lines is to be included in the cost of the pipe.
- (Q) What is the desired finish on the handrails?
- (A) The finish for the handrail shall be powder coated.
- (Q) The 12" and 8" sanitary notes say C-900 is required, can the 6" be SDR 35?
- (A) Per CBU Construction Specifications, section 4.4.2.1.1.1, for gravity sewer lines SDR 35 can be used. For pressure sanitary sewers see section 4.4.3.2.1 for allowable pipe types.
- (Q) There are no items to pay for the forcemain work? How is that work to be paid for?
- (A) The quantity for the 6 inch forcemain was inadvertently included in the Pay item "Pipe, Sanitary Sewer 6 In.". The quantity for "Pipe, Sanitary Sewer 6 In." has been revised to only include the 6 inch gravity sanitary sewer and the item "Forcemain" will be added to the contract. The updated "Proposal Schedule of Items" has been added per this addendum.
- (Q) Who is responsible for the taps for the 24", 12", 8" and service connections?
- (A) Per CBU Construction Specifications section 4.5.3.4.6. taps will be made by City Utilities for mains. For service connections, per section 4.5.3.6.2, contractor can make service taps on the newly-installed main. For the existing main taps, per section 4.5.3.6.1, CBU shall make the taps.
- (Q) Are there any CBU fees that the contractor is responsible for?
- (A) Any fees and or meter cost will be paid by the Contractor. The Contractor shall submit a reimbursement request for the exact amount without any mark-up to the City of Bloomington.
- (Q) For the manhole modifications on plan sheet 52 will new steps need to be installed in the manholes?
- (A) Yes, steps will need to be installed per CBU Construction Specifications, section 4.5.2.1.7.3.
- (Q) Will the modified manholes need to be pressure tested?
- (A) Yes, the manholes will need to be air pressure tested per CBU Construction Specifications, section 4.5.8.1.1.
- (Q) Can the top row of block be smooth faced to aid in forming and pouring the cast in place coping?
- (A) No, The block facing is to be as called out on the plans.

(Q) Where is the "Pipe Plug Existing" item? Not shown on plans.

(A) The pay item "Pipe Plug Existing" is not required and will be deleted. A revised "Proposal Schedule of Items" has been added per this addendum.

(Q) How will the cast in place concrete coping on top of the retaining wall be paid for?

(A) The coping is included in the square foot area of the Retaining Walls. The work shall be included in the item "Retaining Wall".

(Q) Would you please confirm the CMU block size for the retaining wall? Details on sheet 41 show 12"x8"x16" and legend on sheets 61 thru 64 have 8"x8"x16".

(A) The CMU block size shall be 12"x8"x16" as shown on the detail on sheet 41.

(Q) Are the Fluted CMU's to be 4 flute or 8 flute?

(A) The Fluted CMU's are to be 4 flute.

(Q) There are 7 new sanitary manholes however there are only pay items for 6 new manholes (not including the 2 that get modified)?

(A) There are 6 new sanitary sewer manholes. A revised "Proposal Schedule of Items" has been added per this addendum.

(Q) There are modifications that will need made to the sanitary manhole @ Sta. 40+00 Line SS-3, however I do not see an item to pay for this work, will there be one be added? Also, can a detail be provided for this manhole's modification requirements?

(A) Yes, an additional Sanitary Manhole, Modified item will be added. No detail will be provided as the only modification will be to core a hole for the new pipe. A revised "Proposal Schedule of Items" has been added per this addendum.

CERTIFIED BY:



NEIL KOPPER, PE

CITY OF BLOOMINGTON

STATE OF INDIANA

Acknowledge receipt of the addendum by submitting a signed copy with your bid proposal.

RECEIVED BY: CONTRACTOR (FIRM AND ADDRESS)

SIGNATURE: _____ **DATE:** _____

PRINTED NAME: _____

TITLE: _____



**City of Bloomington
Planning and Transportation Department**

Letting Date: January 29, 2019

Proposal Schedule of Items (Unit Prices)

Project Title : 17th Street Reconstruction

LINE	INDOT CODE	DESCRIPTION	Approximate Quantity and Units	UNITS	UNIT PRICE	BID AMOUNT
001	105-06845	CONSTRUCTION ENGINEERING	1.00	LS	_____	_____
002	110-01001	MOBILIZATION AND DEMOBILIZATION	1.00	LS	_____	_____
003	201-02245	TREE 6 IN., REMOVE	6.00	EACH	_____	_____
004	201-02250	TREE 10 IN., REMOVE	12.00	EACH	_____	_____
005	201-02255	TREE 18 IN., REMOVE	23.00	EACH	_____	_____
006	201-02260	TREE 30 IN., REMOVE	7.00	EACH	_____	_____
007	201-02265	TREE 48 IN., REMOVE	4.00	EACH	_____	_____
008	201-52370	CLEARING RIGHT OF WAY	1.00	LS	_____	_____
009	202-02240	PAVEMENT, REMOVAL	158.00	SYS	_____	_____
0010	202-02278	CURB, CONCRETE, REMOVE	588.00	LFT	_____	_____
0011	202-02279	CURB & GUTTER, REMOVE	169.00	LFT	_____	_____
0012	202-52710	SIDEWALK, CONCRETE, REMOVE	900.00	SYS	_____	_____
0013	202-91385	INLET, REMOVE	5.00	EACH	_____	_____
0014	202-96133	PIPE, REMOVE	330.00	LFT	_____	_____
0015	203-02000	EXCAVATION, COMMON	6841.00	CYS	_____	_____
0016	203-02010	EXCAVATION, ROCK	375.00	CYS	_____	_____
0017	205-12108	STORM WATER MANAGEMENT BUDGET	46677.50	DOL	\$1.00	\$46,677.50
0018	205-12111	SWQCP PREPARATION AND IMPLEMENTATION, LEVEL 1	1.00	LS	_____	_____
0019	206-51215	EXCAVATION, X	1688.00	CYS	_____	_____
0020	207-08264	SUBGRADE TREATMENT, TYPE II	1333.00	SYS	_____	_____
0021	207-08266	SUBGRADE TREATMENT, TYPE III	1274.00	SYS	_____	_____
0022	207-09935	SUBGRADE TREATMENT, TYPE IB	6335.00	SYS	_____	_____
0023	211-09264	STRUCTURAL BACKFILL, TYPE 1	3073.00	CYS	_____	_____
0024	301-07448	COMPACTED AGGREGATE, NO. 53, BASE	1512.00	TON	_____	_____
0025	301-07449	COMPACTED AGGREGATE, NO. 73	98.00	TON	_____	_____
0026	306-08034	MILLING, ASPHALT, 1 1/2 IN.	181.00	SYS	_____	_____
0027	401-06264	PROFILOGRAPH, HMA	1.00	LS	_____	_____
0028	401-07321	QC/QA-HMA, 2, 64, SURFACE, 9.5 mm	428.00	TON	_____	_____
0029	401-07390	QC/QA-HMA, 2, 64, INTERMEDIATE, 19.0 mm	686.00	TON	_____	_____
0030	401-07407	QC/QA-HMA, 2, 64, BASE, 25.0 mm	819.00	TON	_____	_____
0031	401-10258	JOINT ADHESIVE, SURFACE	1836.00	LFT	_____	_____
0032	401-10259	JOINT ADHESIVE, INTERMEDIATE	1836.00	LFT	_____	_____
0033	401-11785	LIQUID ASPHALT SEALANT	1836.00	LFT	_____	_____
0034	406-05520	ASPHALT FOR TACK COAT	4.30	TON	_____	_____
0035		PCCP, PLAIN, VARIABLE DEPTH	55.00	SYS	_____	_____
0036	604-05528	HMA FOR SIDEWALK	319.00	TON	_____	_____
0037	604-06070	SIDEWALK, CONCRETE	1126.00	SYS	_____	_____
0038	604-08086	CURB RAMP, CONCRETE	115.00	SYS	_____	_____
0039	604-12083	DETECTABLE WARNING SURFACES	24.00	SYS	_____	_____
0040	604-92237	HAND RAIL, STEEL	1122.00	LFT	_____	_____
0041	605-06090	CURB, INTEGRAL, CONCRETE	28.00	LFT	_____	_____
0042	605-06120	CURB, CONCRETE	358.00	LFT	_____	_____
0043	605-06155	CURB AND GUTTER, CONCRETE, MODIFIED	2916.00	LFT	_____	_____
0044	605-94811	CURB TURNOUT	1.00	EACH	_____	_____
0045	610-07487	HMA FOR APPROACHES, TYPE B	211.00	TON	_____	_____
0046	610-08446	PCCP FOR APPROACHES, 6 IN	624.00	SYS	_____	_____
0047	610-09108	PCCP FOR APPROACHES, 9 IN	177.00	SYS	_____	_____
0048	611-06497	MAILBOX ASSEMBLY, SINGLE	18.00	EACH	_____	_____

0049	615-06505	MONUMENT, TYPE B	2.00	EACH	_____ - _____ -
0050	615-06490	RIGHT-OF-WAY MARKER	33.00	EACH	_____ - _____ -
0051	616-06405	RIPRAP, REVETMENT	15.00	TON	_____ - _____ -
0052	621-06567	WATER	22.00	KGAL	_____ - _____ -
0053	621-06575	SODDING, NURSERY	6033.00	SYS	_____ - _____ -
0054	621-98038	MULCH HARDWOOD SHREDDED BARK	3.00	CYS	===== =====
0055	622-05638	PLANT, DECIDUOUS SHRUB	8.00	EACH	_____ - _____ -
0056	622-05649	PLANT, DECIDUOUS TREE, 1.25 IN. TO 2 IN.	61.00	EACH	_____ - _____ -
0057	628-09401	FIELD OFFICE, A	9.00	MOS	_____ - _____ -
0058	702-51015	CONCRETE, B, FOOTINGS	561.00	CYS	_____ - _____ -
0059	703-06028	REINFORCING BARS	46778.00	LBS	_____ - _____ -
0060	714-05562	RETAINING WALL	6378.50	SFT	_____ - _____ -
0061	715-05048	PIPE, TYPE 4, CIRCULAR, 6 IN	554.00	LFT	_____ - _____ -
0062	715-05149	PIPE, TYPE 2, CIRCULAR, 12 IN	2461.00	LFT	_____ - _____ -
0063	715-05151	PIPE, TYPE 2, CIRCULAR, 15 IN	1512.00	LFT	_____ - _____ -
0064	715-05152	PIPE, TYPE 2, CIRCULAR, 18 IN	76.00	LFT	_____ - _____ -
0065	715-46000	PIPE END SECTION, DIAMETER 12 IN.	1.00	EACH	_____ - _____ -
0066	715-46005	PIPE END SECTION, DIAMETER 15 IN.	1.00	EACH	_____ - _____ -
0067	718-52610	AGGREGATE FOR UNDERDRAINS	456.00	CYS	_____ - _____ -
0068	718-99153	GEOTEXTILES FOR UNDERDRAIN	56.00	SYS	_____ - _____ -
0069	720-02442	PIPE PLUG EXIST.	4.00	EACH	_____ - _____ -
0070	720-44000	CASTING, ADJUST TO GRADE, STORM	2.00	EACH	_____ - _____ -
0071	720-45005	INLET, A2	1.00	EACH	_____ - _____ -
0072	720-45030	INLET, E7	2.00	EACH	_____ - _____ -
0073	720-45045	INLET, J10	7.00	EACH	_____ - _____ -
0074	720-45235	CATCH BASIN, E7	2.00	EACH	_____ - _____ -
0075	720-45250	CATCH BASIN, K10	17.00	EACH	_____ - _____ -
0076	720-45410	MANHOLE, C4	26.00	EACH	_____ - _____ -
0077	720-91352	CATCH BASIN, F7	2.00	EACH	_____ - _____ -
0078	720-98687	CATCH BASIN, M10	10.00	EACH	_____ - _____ -
0079		AQUA-SWIRL, A-3 (OR EQUAL)	2.00	EACH	_____ - _____ -
0080		AQUA-SWIRL, A-4 (OR EQUAL)	2.00	EACH	_____ - _____ -
0081	801-04308	ROAD CLOSURE SIGN ASSEMBLY	5.00	EACH	_____ - _____ -
0082	801-06586	CONSTRUCTION SIGN, A	8.00	EACH	_____ - _____ -
0083	801-06625	DETOUR ROUTE MARKER ASSEMBLY	19.00	EACH	_____ - _____ -
0084	801-06775	MAINTAINING TRAFFIC	1.00	LS	_____ - _____ -
0085	801-07119	BARRICADE, TYPE III-B	15.00	EACH	_____ - _____ -
0086	802-04089	SIGN, SHEET, REMOVE	1.00	EACH	_____ - _____ -
0087	802-05701	SIGN POST, SQUARE TYPE 1 REINFORCED ANCHOR BASE	96.00	LFT	_____ - _____ -
0088	802-07059	SIGN, SHEET, AND SUPPORTS, REMOVE	15.00	EACH	_____ - _____ -
0089	802-07060	SIGN, SHEET,RELOCATE	1.00	EACH	_____ - _____ -
0090	802-09838	SIGN, SHEET WITH LEGEND, 0.080 IN. THICKNESS	69.75	SFT	_____ - _____ -
0091	802-09840	SIGN, SHEET WITH LEGEND, 0.100 IN. THICKNESS	52.54	SFT	_____ - _____ -
0092	808-03439	TRANSVERSE MARKING, THERMOPLASTIC, CROSSWALK LINE, 24 IN.	106.00	LFT	_____ - _____ -
0093	808-06609	PAVEMENT MESSAGE MARKING, CHEVRON	2.00	EACH	_____ - _____ -
0094	808-75245	LINE, THERMOPLASTIC, SOLID, YELLOW, 4 IN.	3593.00	LFT	_____ - _____ -
0095	808-75297	TRANSVERSE MARKING,THERMOPLASTIC, STOP LINE, WHITE 24 IN.	40.00	LFT	_____ - _____ -
0096	808-75300	TRANSVERSE MARKING,THERMOPLASTIC, CROSSWALK LINE, WHITE 6 IN.	155.00	LFT	_____ - _____ -
0097	808-75998	SNOWPLOWABLE RAISED PAVEMENT MARKER	26.00	EACH	_____ - _____ -
UTILITY ITEMS					
0098		GATE VALVE WITH VALVE BOX, DUCTILE IRON, 6 IN.	2.00	EACH	_____ - _____ -
0099		GATE TAPPING VALVE, WITH BOX, DUCTILE IRON, 8 IN.	2.00	EACH	_____ - _____ -
0100		GATE TAPPING VALVE, WITH BOX, DUCTILE IRON, 12 IN.	1.00	EACH	_____ - _____ -
0101		GATE TAPPING VALVE, WITH BOX, DUCTILE IRON, 24 IN.	2.00	EACH	_____ - _____ -
0102	720-03194	SANITARY MANHOLE (CBU STANDARD DETAIL 1)	6.00	EACH	_____ - _____ -

0103	720-03194	SANITARY MANHOLE MODIFIED (DETAIL 1)	1.00	EACH	_____ - _____ - _____
0104	720-03194	SANITARY MANHOLE MODIFIED (DETAILS 2 & 3)	2.00	EACH	_____ - _____ - _____
0105	715-05711	PIPE, SANITARY SEWER 6 IN.	28.00	LFT	_____ - _____ - _____
0106	715-05408	PIPE, SANITARY SEWER 8 IN.	80.00	LFT	_____ - _____ - _____
0107	715-05411	PIPE, SANITARY SEWER 12 IN.	248.00	LFT	_____ - _____ - _____
0108		WATER MAIN, DUCTILE IRON, 24 IN.	860.00	LFT	_____ - _____ - _____
0109	715-08250	WATER MAIN, DUCTILE IRON, 12 IN.	28.00	LFT	_____ - _____ - _____
0110	715-11571	WATER MAIN, DUCTILE IRON, 8 IN.	56.00	LFT	_____ - _____ - _____
0111	715-94780	WATER MAIN, DUCTILE IRON, 6 IN.	56.00	LFT	_____ - _____ - _____
0112	720-02442	PIPE-PLUG-EXIST.	1.00	EACH	_____ - _____ - _____
0113	720-91742	FIRE HYDRANT	3.00	EACH	_____ - _____ - _____
0114	715-04994	WATER METER AND SERVICE (CBU STANDARD DETAIL 10)	19.00	EACH	_____ - _____ - _____
0115	621-90853	TAPPING SLEEVE, 24 IN.	2.00	EACH	_____ - _____ - _____
0116	621-90853	TAPPING SLEEVE, 6 IN.	1.00	EACH	_____ - _____ - _____
0117	621-90853	TAPPING SLEEVE, 8 IN.	2.00	EACH	_____ - _____ - _____
0118	621-90853	TAPPING SLEEVE, 12 IN.	1.00	EACH	_____ - _____ - _____
0119		LINE STOP, 24 IN.	2.00	EACH	_____ - _____ - _____
0120		LINE STOP, 12 IN.	1.00	EACH	_____ - _____ - _____
0121		LINE STOP, 8 IN.	2.00	EACH	_____ - _____ - _____
0122	202-97009	FIRE HYDRANT ASSEMBLY, REMOVE	1.00	EACH	_____ - _____ - _____
0123	202-93047	MANHOLE, REMOVE	2.00	EACH	_____ - _____ - _____
0124	202-96133	PIPE, REMOVE	791.00	LFT	_____ - _____ - _____
0125	202-02637	PIPE, ABANDON AND GROUT FILL	482.00	LFT	_____ - _____ - _____

LIGHTING ITEMS

0126	807-02191	HANDHOLE, LIGHTING	22.00	EACH	_____ - _____ - _____
0127	807-12217	LIGHT-POLE FOUNDATION	22.00	EACH	_____ - _____ - _____
0128	805-11813	CONDUIT, PVC, ELECTRICAL GRADE, 2"	2720.00	LFT	_____ - _____ - _____

FIBER OPTIC ITEMS

0129		MANHOLE, FIBER OPTIC	10.00	EACH	_____ - _____ - _____
0130	805-95568	CONDUIT, PVC, 4 IN.	5099.00	LFT	_____ - _____ - _____

ADDENDUM NO. 1

0131		RELOCATE NEIGHBORHOOD SIGN	1.00	LS	_____ - _____ - _____
0132	109-08440	QUALITY ADJUSTMENTS, HMA		DOL	\$1.00
0133	109-08443	QUALITY ADJUSTMENTS, TEMPORARY TRAFFIC CONTROL DEVICES		DOL	\$1.00
0134	621-06570	TOPSOIL	500.00	CYS	_____ - _____ - _____
0135	715-98961	FORCE MAIN	328.00	LFT	_____ - _____ - _____
0136		GATE TAPPING VALVE, WITH BOX, DUCTILE IRON, 6 IN.	1.00	EACH	_____ - _____ - _____
0137		GATE VALVE, WITH BOX, DUCTILE IRON, 8 IN.	2.00	EACH	_____ - _____ - _____
0138		GATE VALVE, WITH BOX, DUCTILE IRON, 12 IN.	1.00	EACH	_____ - _____ - _____
0137		SPLIT CASING, 4"	105.00	LFT	_____ - _____ - _____
0138		SPLIT CASING, 12"	75.00	LFT	_____ - _____ - _____
0141	720-03194	SANITARY MANHOLE MODIFIED	1.00	EACH	_____ - _____ - _____

TOTAL PROJECT BID: _____

POST-MOUNTED STREET NAME SIGN



OVERHEAD STREET NAME SIGN



NOTES:


1. BACKGROUND FOR PUBLIC ROAD STREET NAME SIGNS SHALL BE GREEN COLOR.
2. BACKGROUND FOR PRIVATE ROAD STREET NAME SIGNS SHALL BE BLUE COLOR.
3. ALL LETTERING FOR STREET NAME SIGNS SHALL BE WHITE COLOR .
4. SIGNS SHALL HAVE A $\frac{1}{2}$ " WHITE BORDER ALONG THE EDGE
5. STREET NAMES WITH A SUPERSCRIPT (E.G., 16TH) SHALL HAVE AN ADDITIONAL $\frac{1}{2}$ " OFFSET BETWEEN THE SUPERSCRIPT TEXT AND THE ADDRESS BLOCK NUMBER ON POST-MOUNTED SIGNS AND AN ADDITIONAL 1" ON OVERHEAD SIGNS.
6. SIGN HEIGHT FROM THE GROUND TO THE BOTTOM OF A POST-MOUNTED STREET SIGN SHALL BE 7'-0" (MINIMUM).



CITY OF BLOOMINGTON

STANDARD TRAFFIC
STREET NAME SIGN DETAILS

STANDARD DRAWING NO.- SS-1


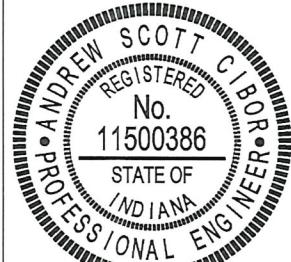


A.L.
ENGINEER

8/21/2018


DATE

NOTE: PROPOSED RIGHT-OF-WAY SHOWN WHERE APPLICABLE. SEE PLANS FOR LOCATION OF EXISTING RIGHT-OF-WAY AND PROPOSED TEMPORARY RIGHT-OF-WAY

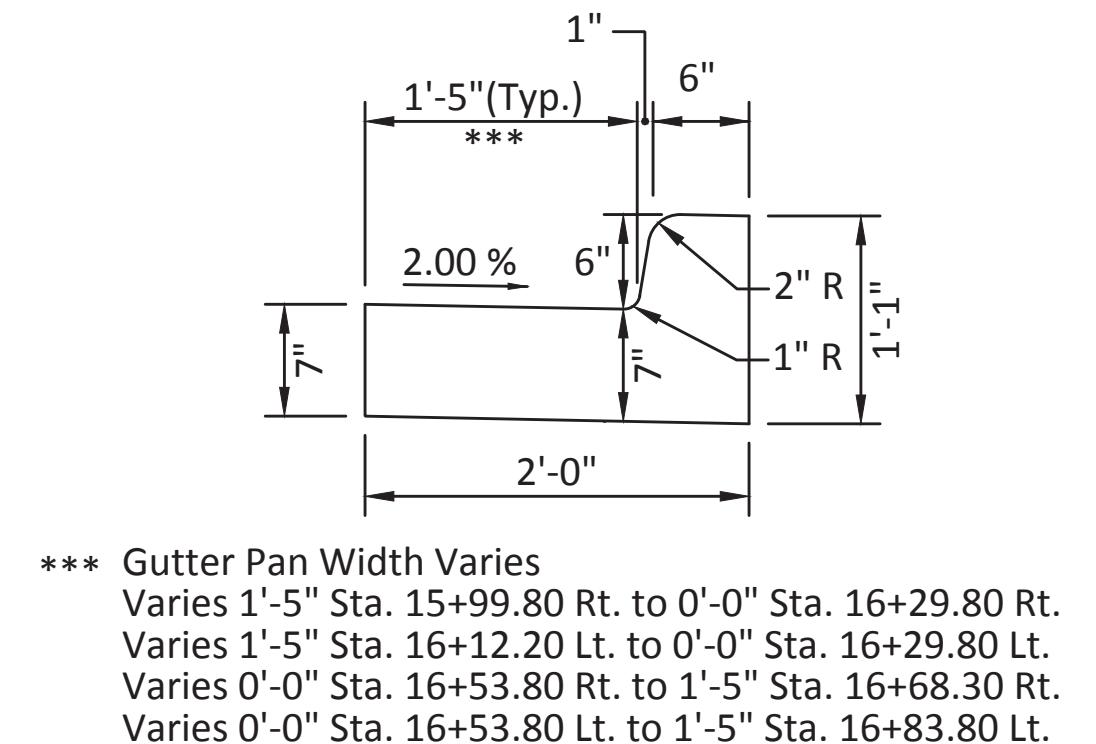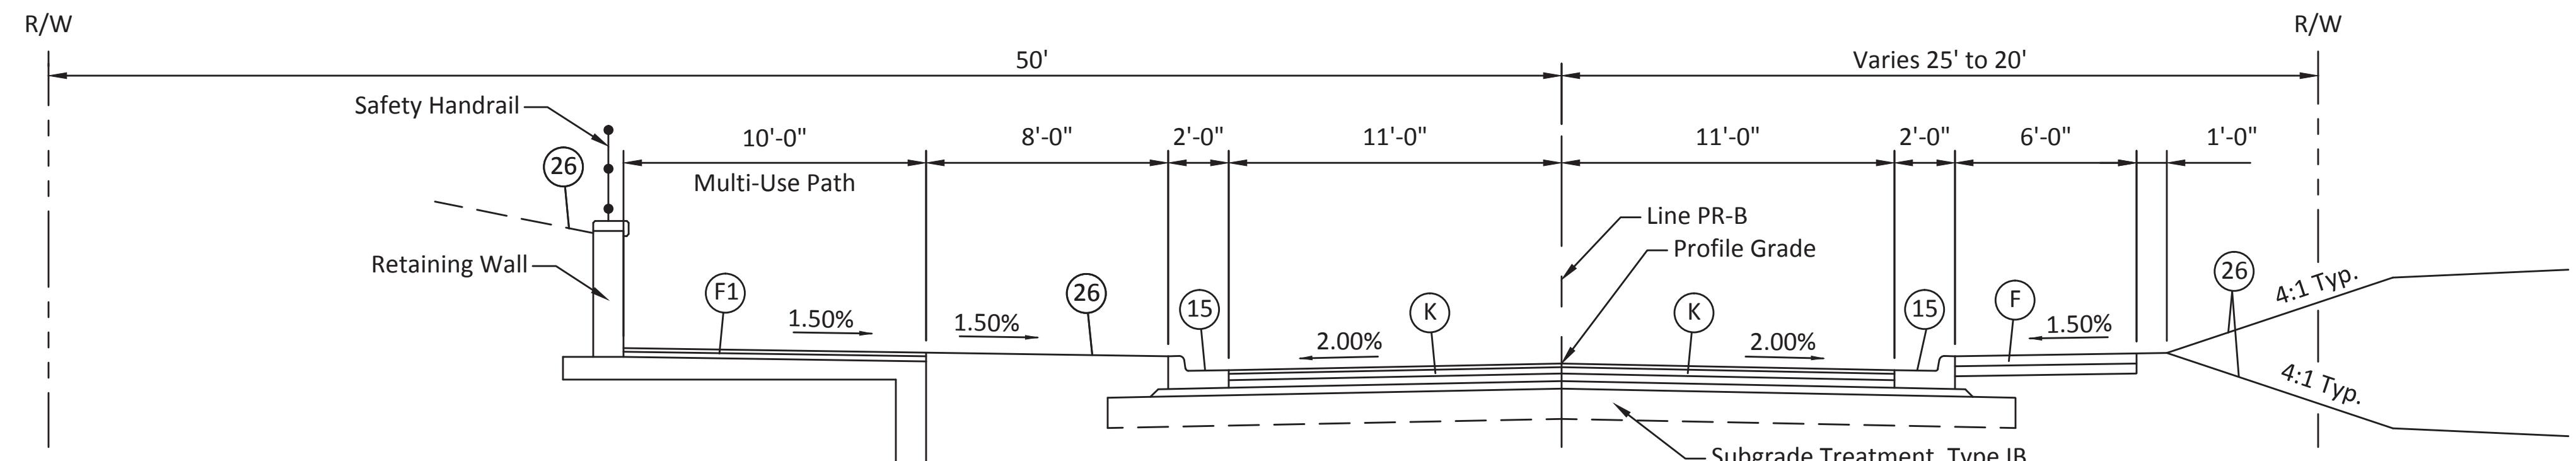


MODIFIED COMBINED CONCRETE CURB AND GUTTER

Scale: 1' = 1'-0"

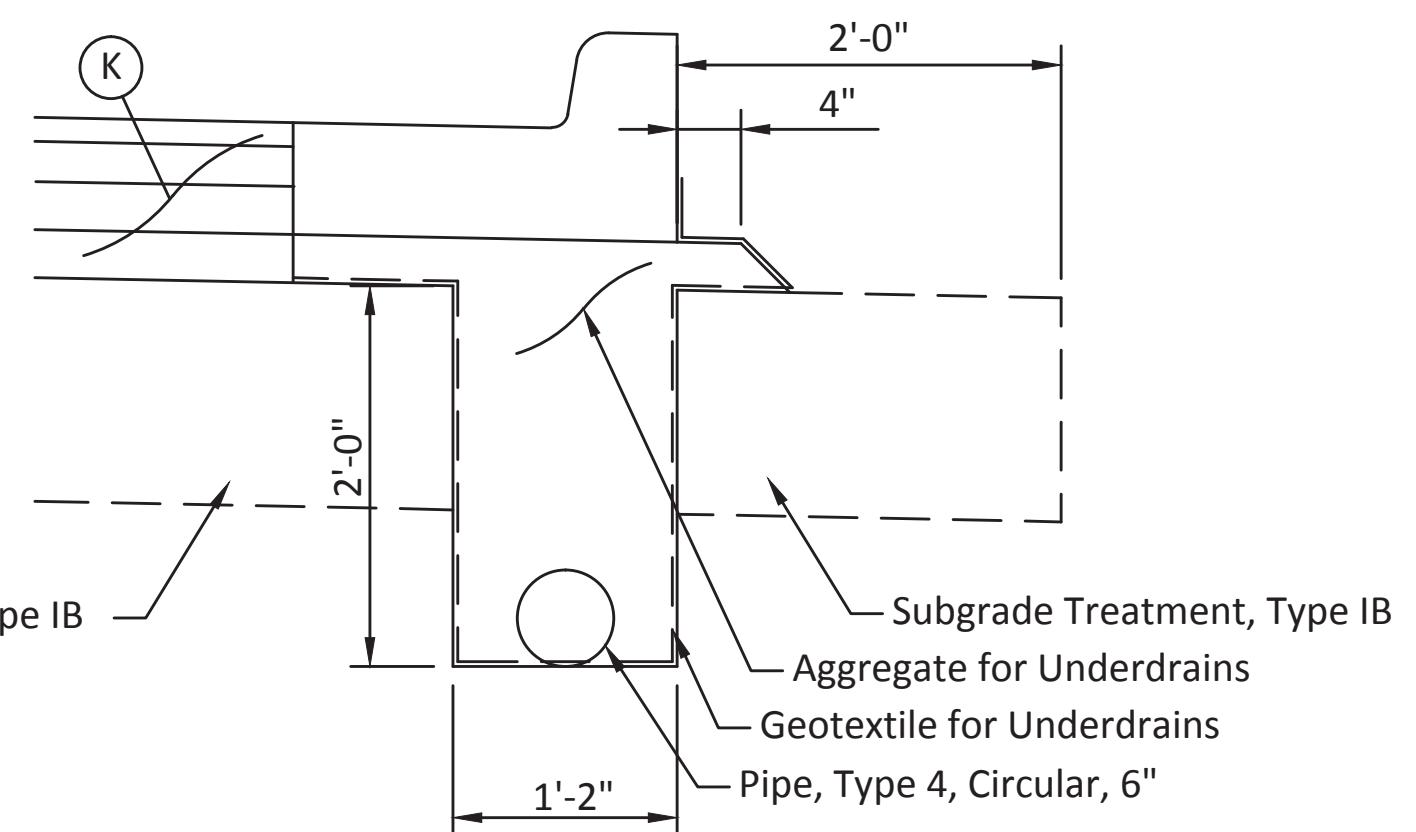

UNDERDRAIN DETAIL

Scale: 1' = 1'-0"

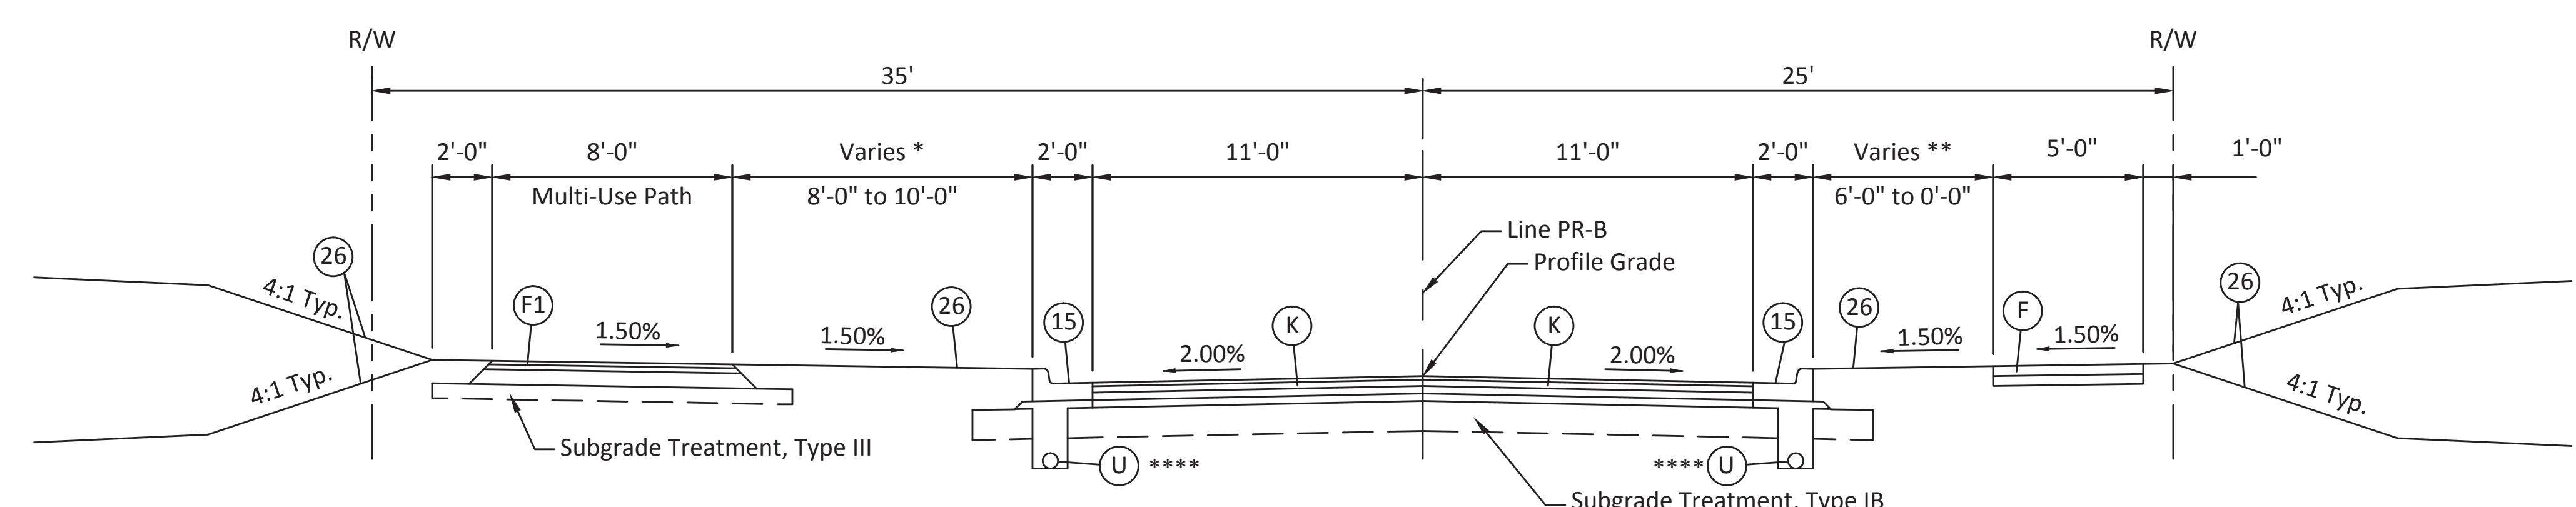

* 10'-0" Sta. 13+66.58 to Sta. 16+81.80
Varies 10'-0" Sta. 16+81.80 to 8'-0" Sta. 17+16.65
8'-0" Sta. 17+16.65 to Sta. 18+78.40

** 6'-0" Sta. 13+66.58 to Sta. 18+51.80
Varies 6'-0" Sta. 18+51.80 to 0'-0" Sta. 18+94.80

**** Begin Underdrain Installation
Sta. 18+40.00


LEGEND

- (F) Concrete Sidewalk, 4 in. on 4 in. Compacted Aggregate, No. 53, Base
- (F1) HMA for Sidewalk:
140#/SYS HMA Surface, Type A on 220#/SYS HMA Intermediate, Type A on 6" Compacted Aggregate, No. 53, Base
- (K) Full Depth HMA Pavement:
165#/SYS QC/QA HMA, 2, 64, Surface 9.5mm on 275#/SYS QC/QA HMA, 2, 64, Intermediate 19.0mm on 330#/SYS QC/QA HMA, 2, 64, Base 25.0mm on 3" Compacted Aggregate, No. 53, Base
- (U) 6" Underdrain
- (C) Concrete Curb
- (13) Combined Concrete Curb and Gutter, Modified
- (15) Subgrade Treatment, Type IB
- (26) Sodding, Nursery

NOTE:

For Legend Item (F1) when on Retaining Wall Footings the Compacted aggregate layer is to be omitted.


NOTE: PROPOSED RIGHT-OF-WAY SHOWN WHERE APPLICABLE. SEE PLANS FOR LOCATION OF EXISTING RIGHT-OF-WAY AND PROPOSED TEMPORARY RIGHT-OF-WAY

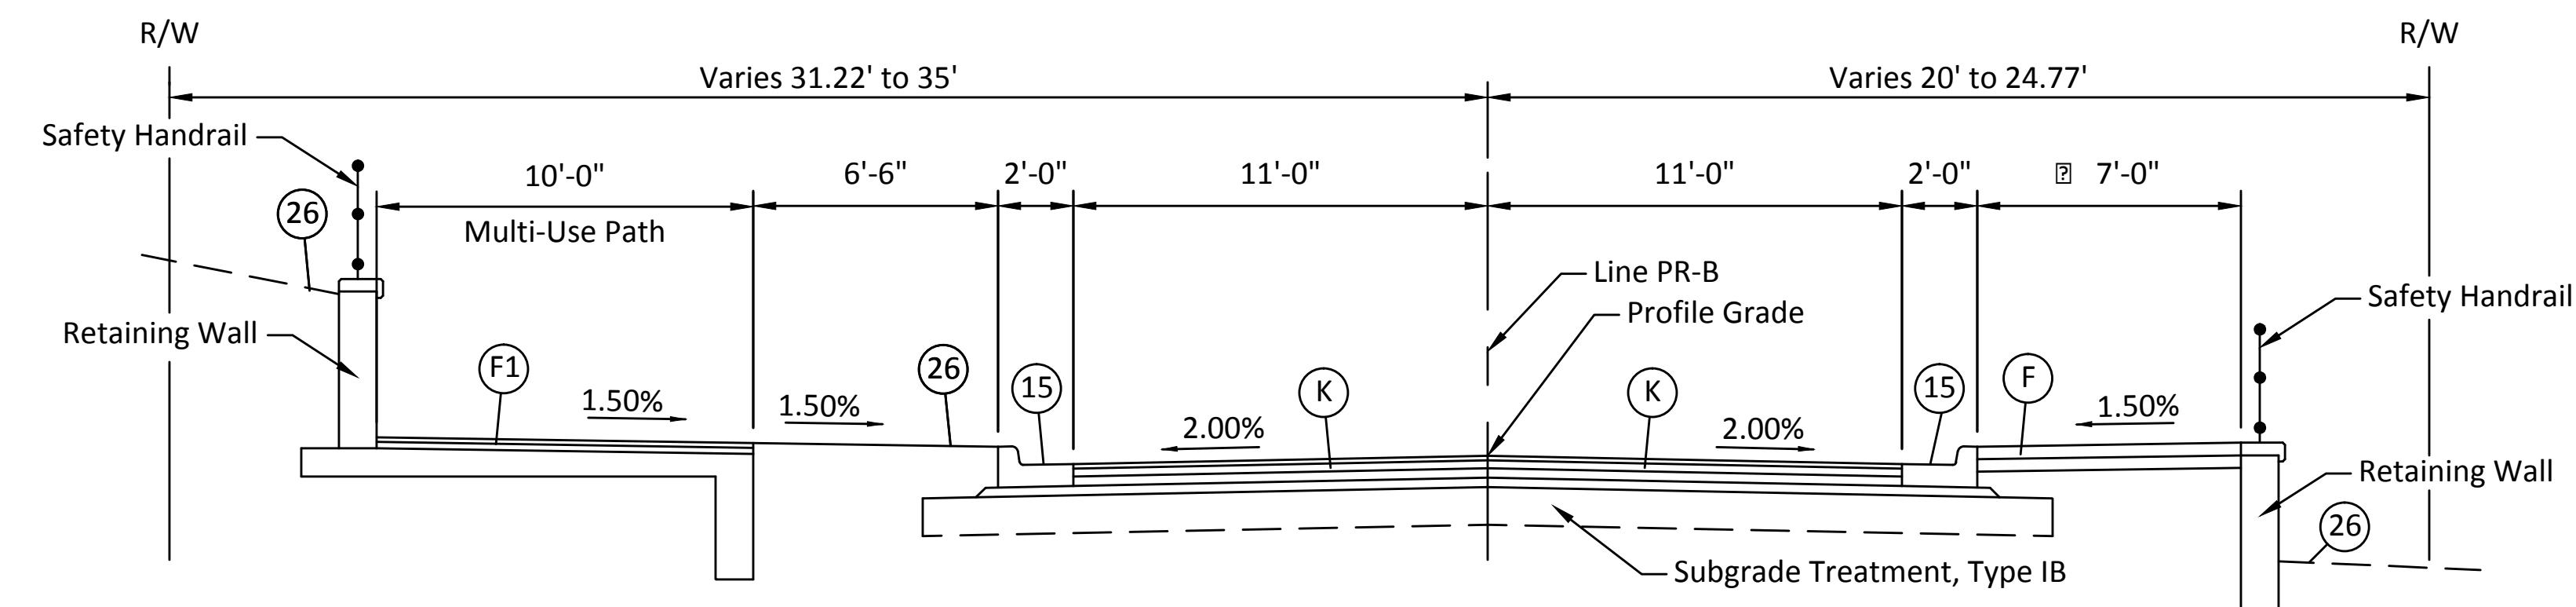

17TH STREET

STA. 24+78.64 TO STA. 26+19.74 "PR-B"


7' Sta. 24+78.64 to Sta. 26+14.74
Varies 7' Sta. 26+14.74 to 7.53" Sta. 26+19.74

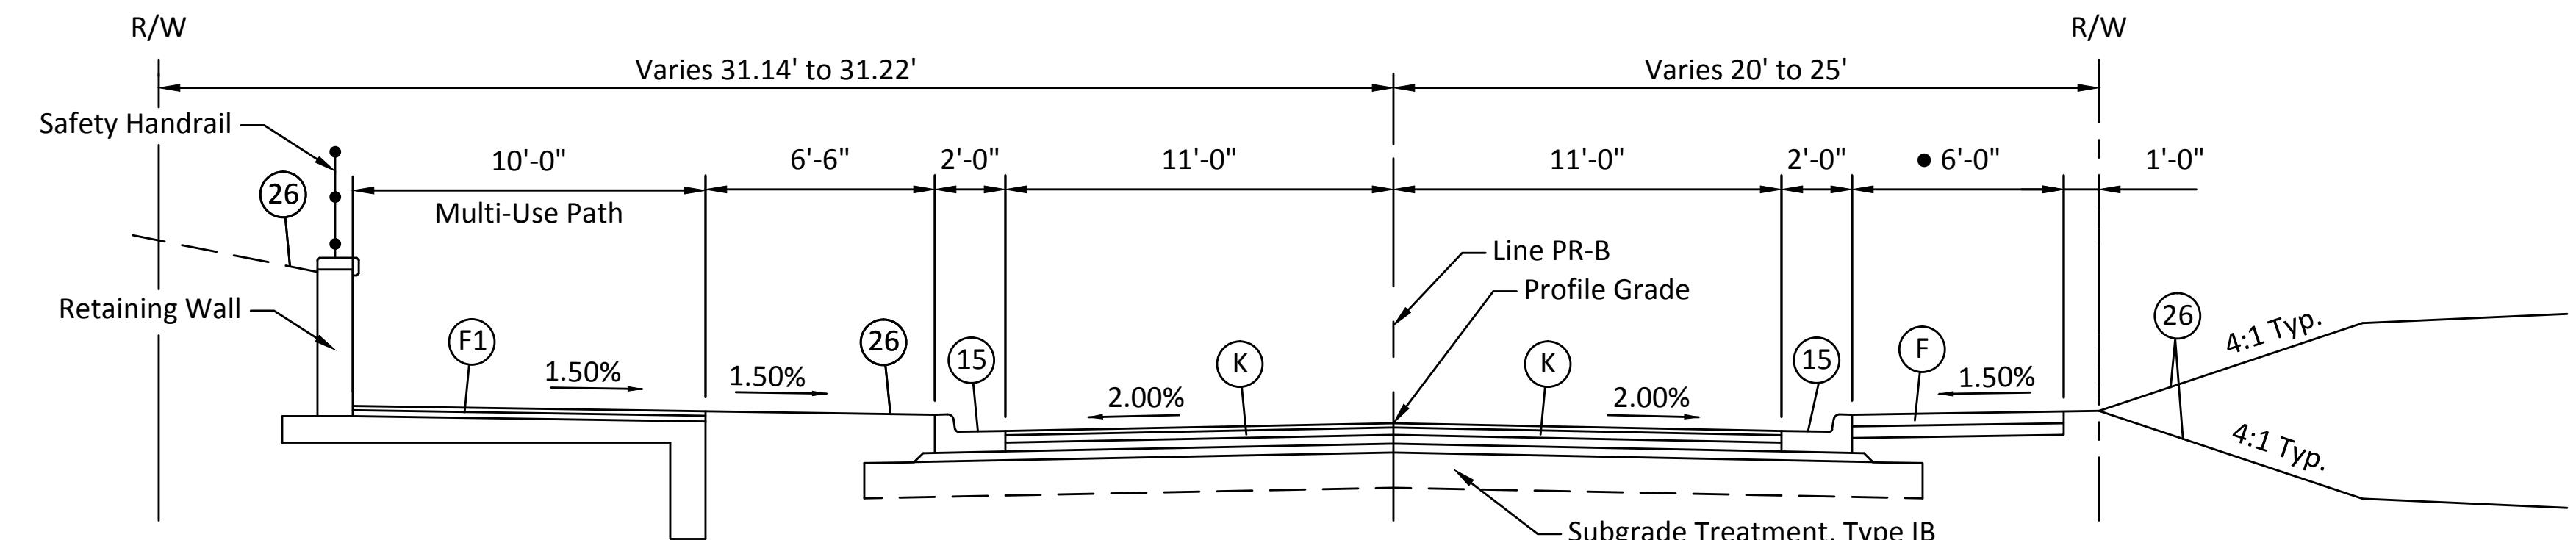

17TH STREET

STA. 23+93.14 TO STA. 24+78.64 "PR-B"

6' Sta. 23+93.14 to Sta. 24+73.64
Varies 6' Sta. 24+73.64 to 7' Sta. 24+78.64

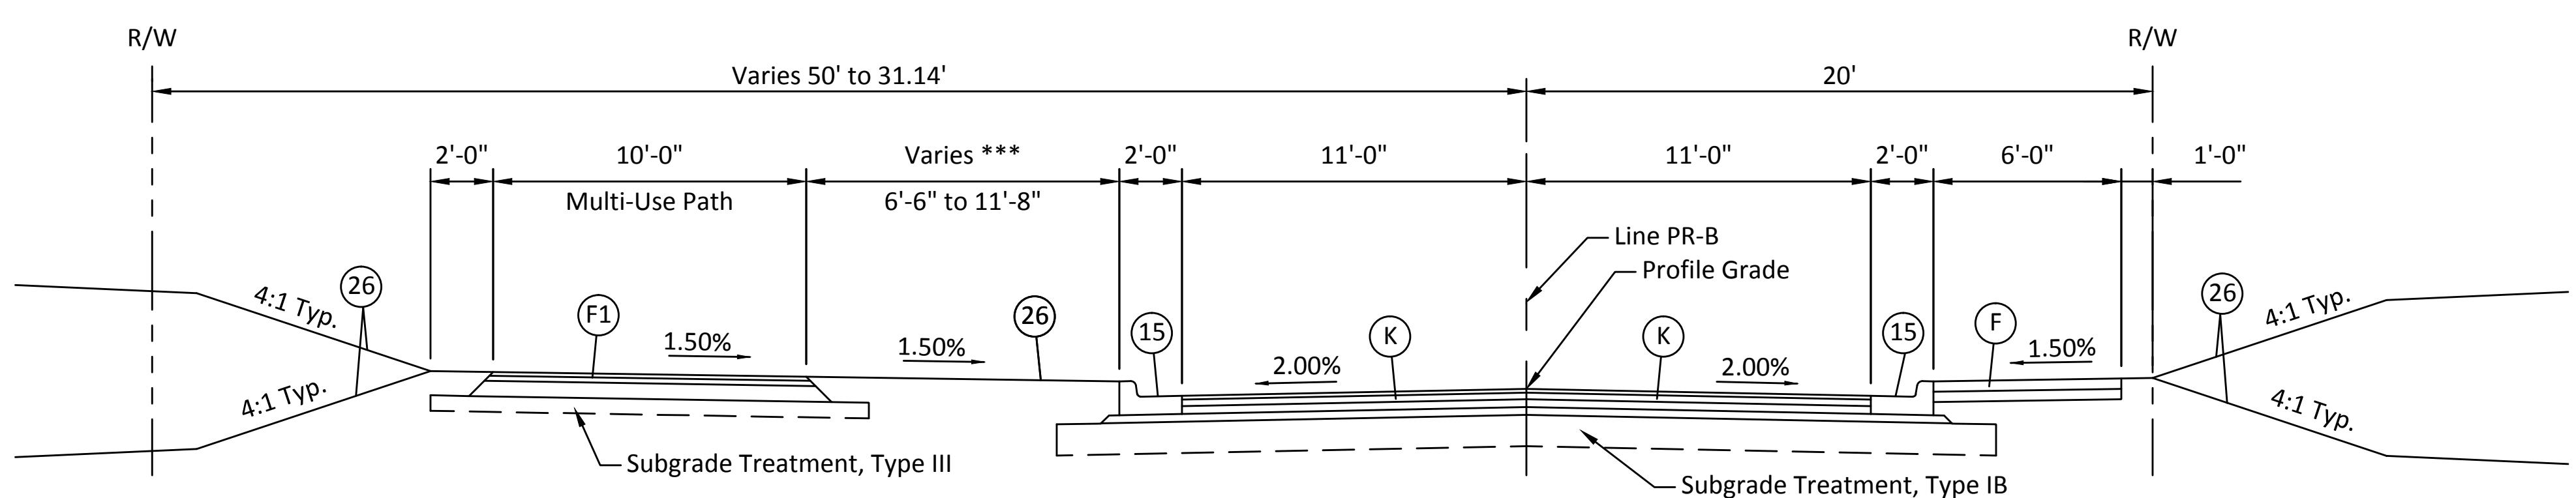

17TH STREET

STA. 22+78.40 TO STA. 23+93.14 "PR-B"

*** 8'-0" Sta. 22+78.40 to Sta. 22+87.70
Varies 8'-0" Sta. 22+87.70 to 11'-8" Sta. 23+17.67
Varies 11'-8" Sta. 23+17.67 to 6'-6" Sta. 23+84.34
6'-6" Sta. 23+84.31 to Sta. 23+93.14

LEGEND

- (F) Concrete Sidewalk, 4 in. on 4 in. Compacted Aggregate, No. 53, Base
- (F1) HMA for Sidewalk:
140 #/SYS HMA Surface, Type A on 220 #/SYS HMA Intermediate, Type A on 6" Compacted Aggregate, No. 53, Base
- (K) Full Depth HMA Pavement:
165 #/SYS QC/QA HMA, 2, 64, Surface 9.5mm on 275 #/SYS QC/QA HMA, 2, 64, Intermediate 19.0mm on 330 #/SYS QC/QA HMA, 2, 64, Base 25.0mm on 3" Compacted Aggregate, No. 53, Base
- (13) Concrete Curb
- (15) Combined Concrete Curb and Gutter, Modified
- (26) Sodding, Nursery

NOTE:

For Legend Item (F1) when on Retaining Wall Footings the Compacted aggregate layer is to be omitted.



RECOMMENDED FOR APPROVAL Brad S. Farns
DESIGN ENGINEER 12/28/18



DESIGNED: BSF DRAWN: BSF
CHECKED: BSF CHECKED: LAR

CITY OF BLOOMINGTON

TYPICAL SECTIONS

SCALE	BRIDGE FILE
1/4" = 1'-0"	N/A
DESIGNATION	N/A
SURVEY BOOK	Sheets
N/A	4 of 100
CONTRACT	PROJECT
N/A	17TH STREET RECONSTRUCTION

NOTE: PROPOSED RIGHT-OF-WAY SHOWN WHERE APPLICABLE. SEE PLANS FOR LOCATION OF EXISTING RIGHT-OF-WAY AND PROPOSED TEMPORARY RIGHT-OF-WAY

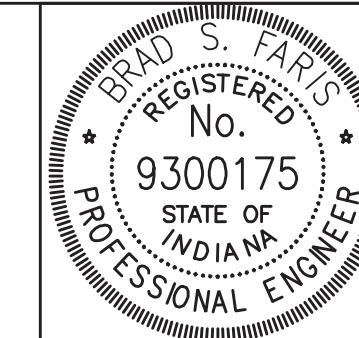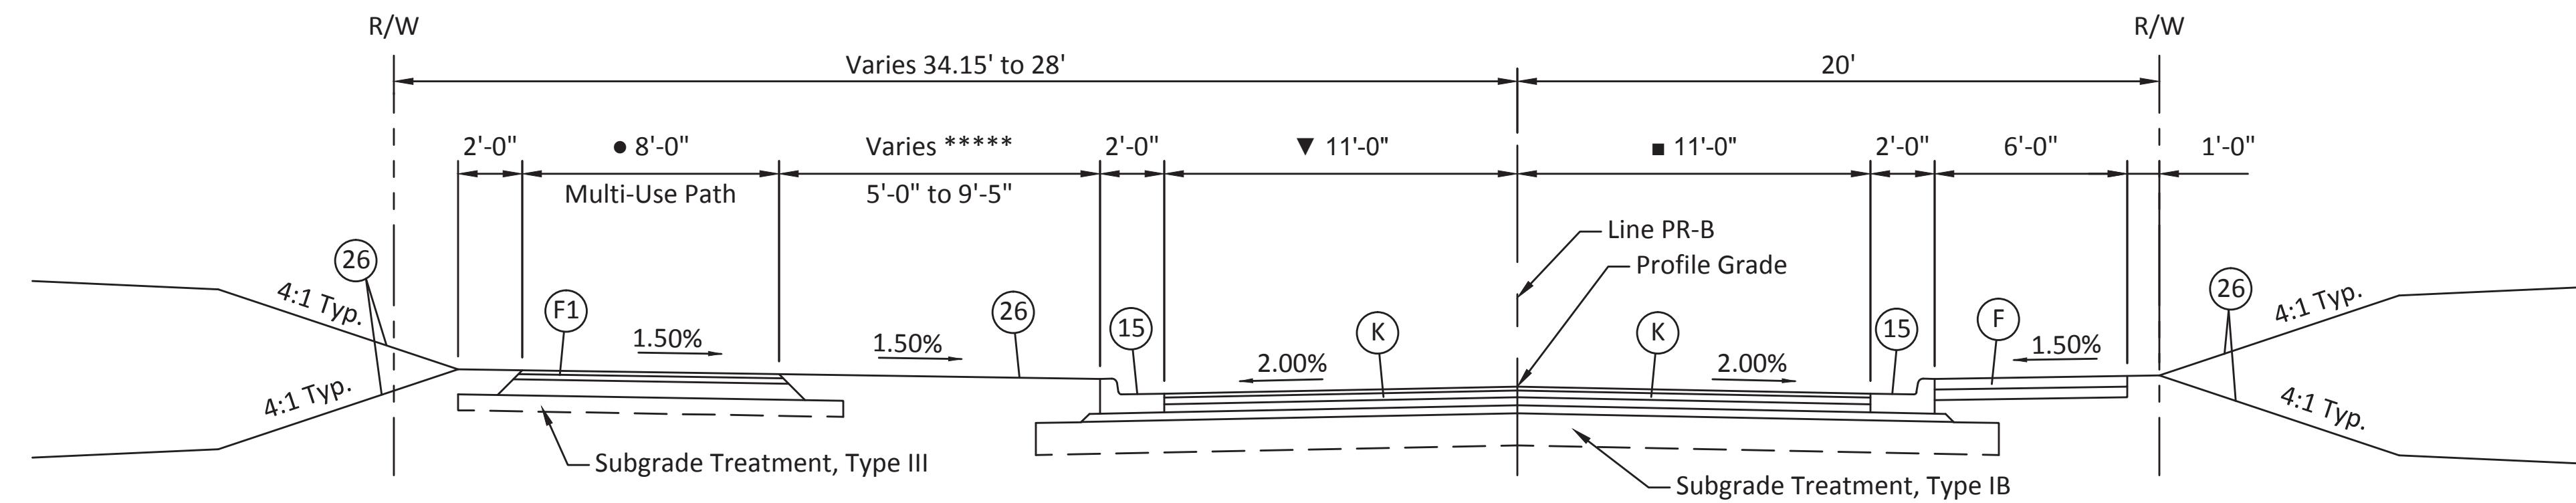

RECOMMENDED FOR APPROVAL *Brad S. Farns* 12/28/18
DESIGN ENGINEER DATE

DESIGNED: BSF DRAWN: BSF
CHECKED: BSF CHECKED: LAR

CITY OF BLOOMINGTON

TYPICAL SECTIONS

LEGEND


- (F) Concrete Sidewalk, 4 in. on 4 in. Compacted Aggregate, No. 53, Base
- (F1) HMA for Sidewalk:
140 #/SYS HMA Surface, Type A on 220 #/SYS HMA Intermediate, Type A on 6" Compacted Aggregate, No. 53, Base
- (K) Full Depth HMA Pavement:
165 #/SYS QC/QA HMA, 2, 64, Surface 9.5mm on 275 #/SYS QC/QA HMA, 2, 64, Intermediate 19.0mm on 330 #/SYS QC/QA HMA, 2, 64, Base 25.0mm on 3" Compacted Aggregate, No. 53, Base
- (13) Concrete Curb
- (15) Combined Concrete Curb and Gutter, Modified
- (26) Sodding, Nursery

NOTE:

For Legend Item (F1) when on Retaining Wall Footings the Compacted aggregate layer is to be omitted.


SCALE	BRIDGE FILE
1/4" = 1'-0"	N/A
	DESIGNATION
	N/A
SURVEY BOOK	Sheets
N/A	5 of 100
CONTRACT	PROJECT
N/A	17TH STREET RECONSTRUCTION

NOTE: PROPOSED RIGHT-OF-WAY SHOWN WHERE APPLICABLE. SEE PLANS FOR LOCATION OF EXISTING RIGHT-OF-WAY AND PROPOSED TEMPORARY RIGHT-OF-WAY

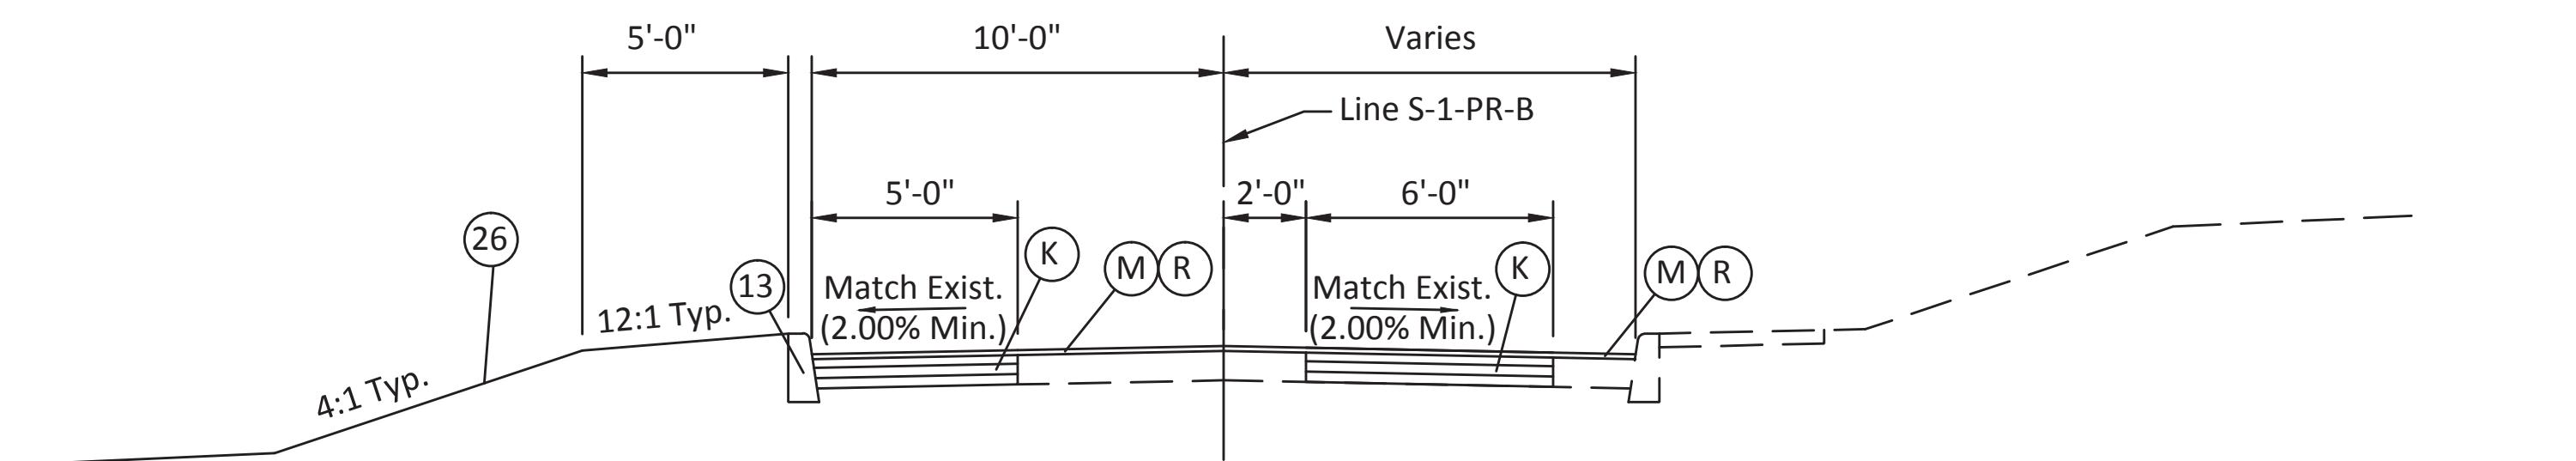

LINDBERGH DRIVE

STA. 101+12.76 TO STA. 102+68.53 "S-1-PR-B"

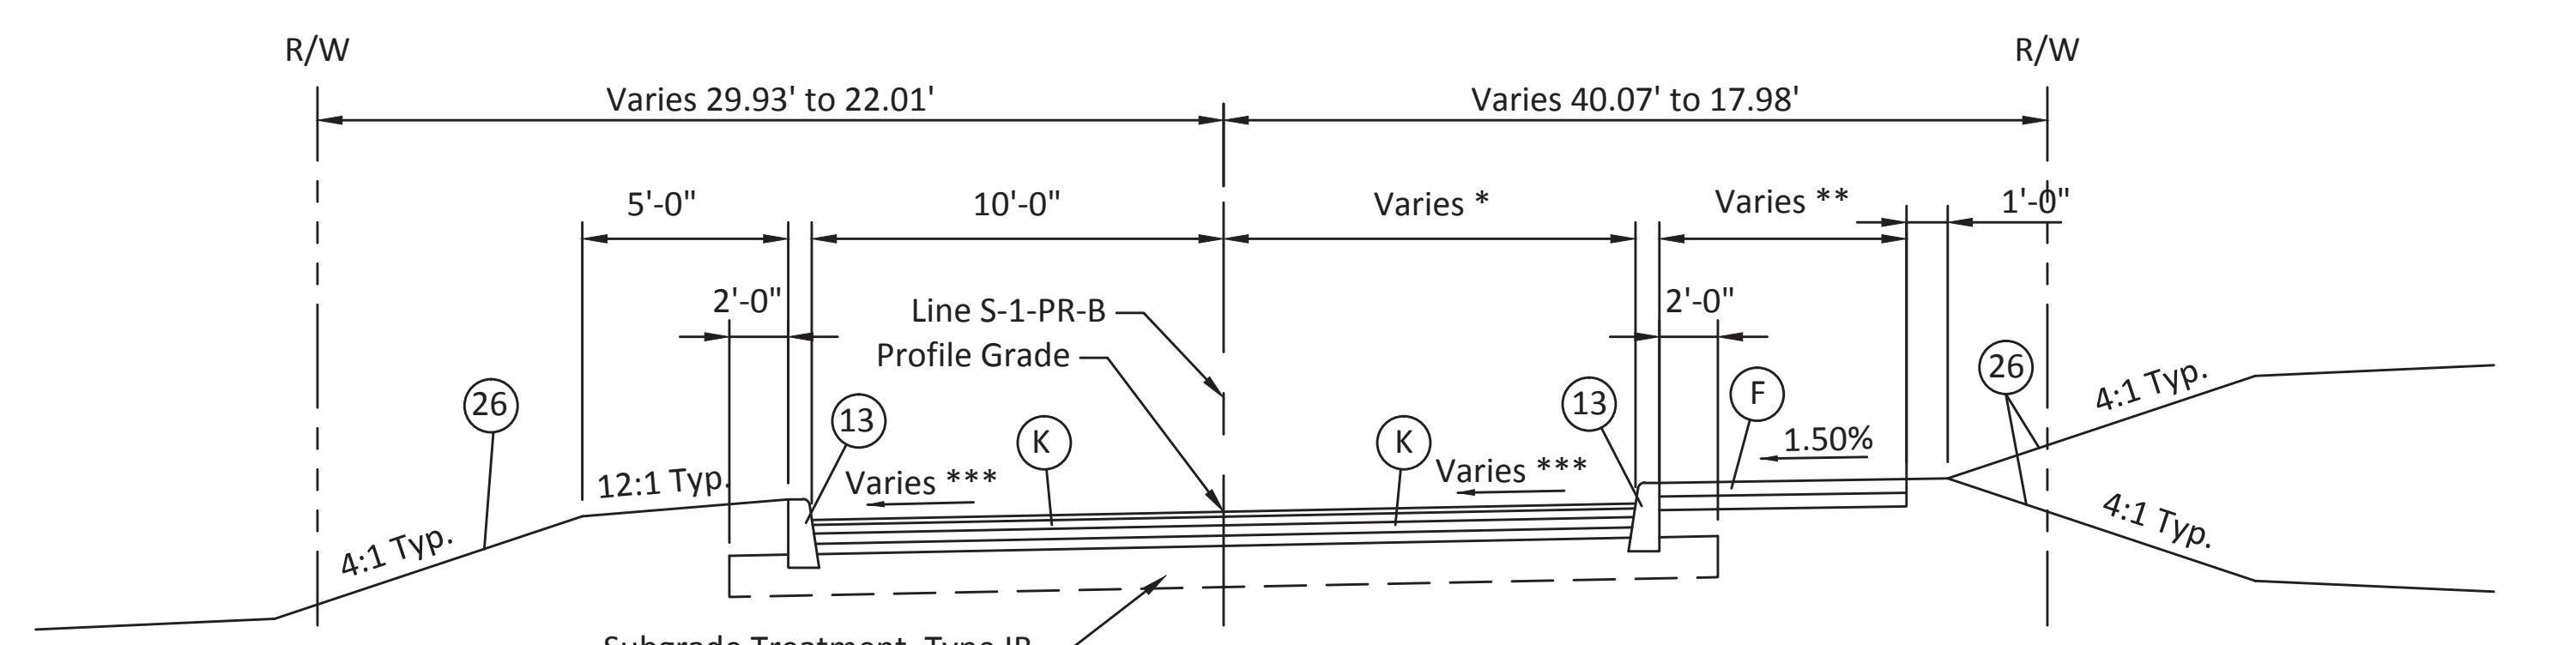

LINDBERGH DRIVE

STA. 100+11.00 TO STA. 101+12.76 "S-1-PR-B"


* 16'-0" Sta. 100+11 to Sta. 100+43.86
Varies 16'-0" Sta. 100+43.86 to 10'-5" Sta. 100+99.30
10'-5" Sta. 100+99.30 to Sta. 101+12.76

** 6'-0" Sta. 100+11 to Sta. 100+99.30
Varies 6'-0" Sta. 100+99.30 to 4'-0" Sta. 100+12.76

*** See Spot Elevation Detail Sheet

LEGEND

- (F) Concrete Sidewalk, 4 in. on 4 in. Compacted Aggregate, No. 53, Base
- (F1) HMA for Sidewalk:
140#/SYS HMA Surface, Type A on 220#/SYS HMA Intermediate, Type A on 6" Compacted Aggregate, No. 53, Base
- (K) Full Depth HMA Pavement:
165#/SYS QC/QA HMA, 2, 64, Surface 9.5mm on 275#/SYS QC/QA HMA, 2, 64, Intermediate 19.0mm on 330#/SYS QC/QA HMA, 2, 64, Base 25.0mm on 3" Compacted Aggregate, No. 53, Base
- (M) Milling, Asphalt, 1 1/2 in.
- (R) 165#/SYS QC/QA HMA, 2, 70, Surface 9.5 mm
- (13) Concrete Curb
- (15) Combined Concrete Curb and Gutter, Modified
- (26) Sodding, Nursery

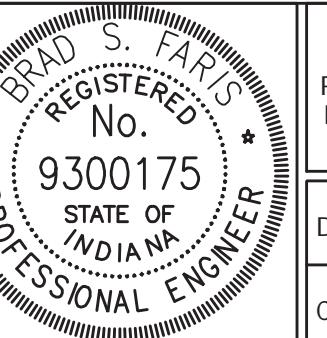

REGISTERED
PROFESSIONAL ENGINEER
STATE OF INDIANA
No. 9300175

RECOMMENDED
FOR APPROVAL

12/28/18

DESIGN ENGINEER

BSF

DRAWN:

BSF

DESIGNED:

CHECKED:

BSF

CHECKED:



LAR

CITY OF BLOOMINGTON

TYPICAL SECTIONS

SCALE	BRIDGE FILE
1/4" = 1'-0"	N/A
DESIGNATION	N/A
SURVEY BOOK	Sheets
N/A	6 of 100
CONTRACT	PROJECT
N/A	17TH STREET RECONSTRUCTION

Rev. 01 01-23-2019

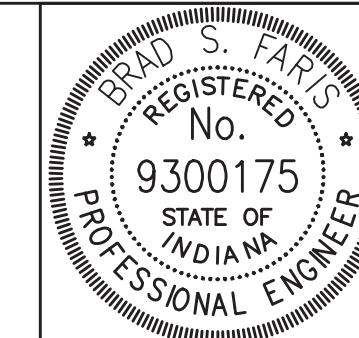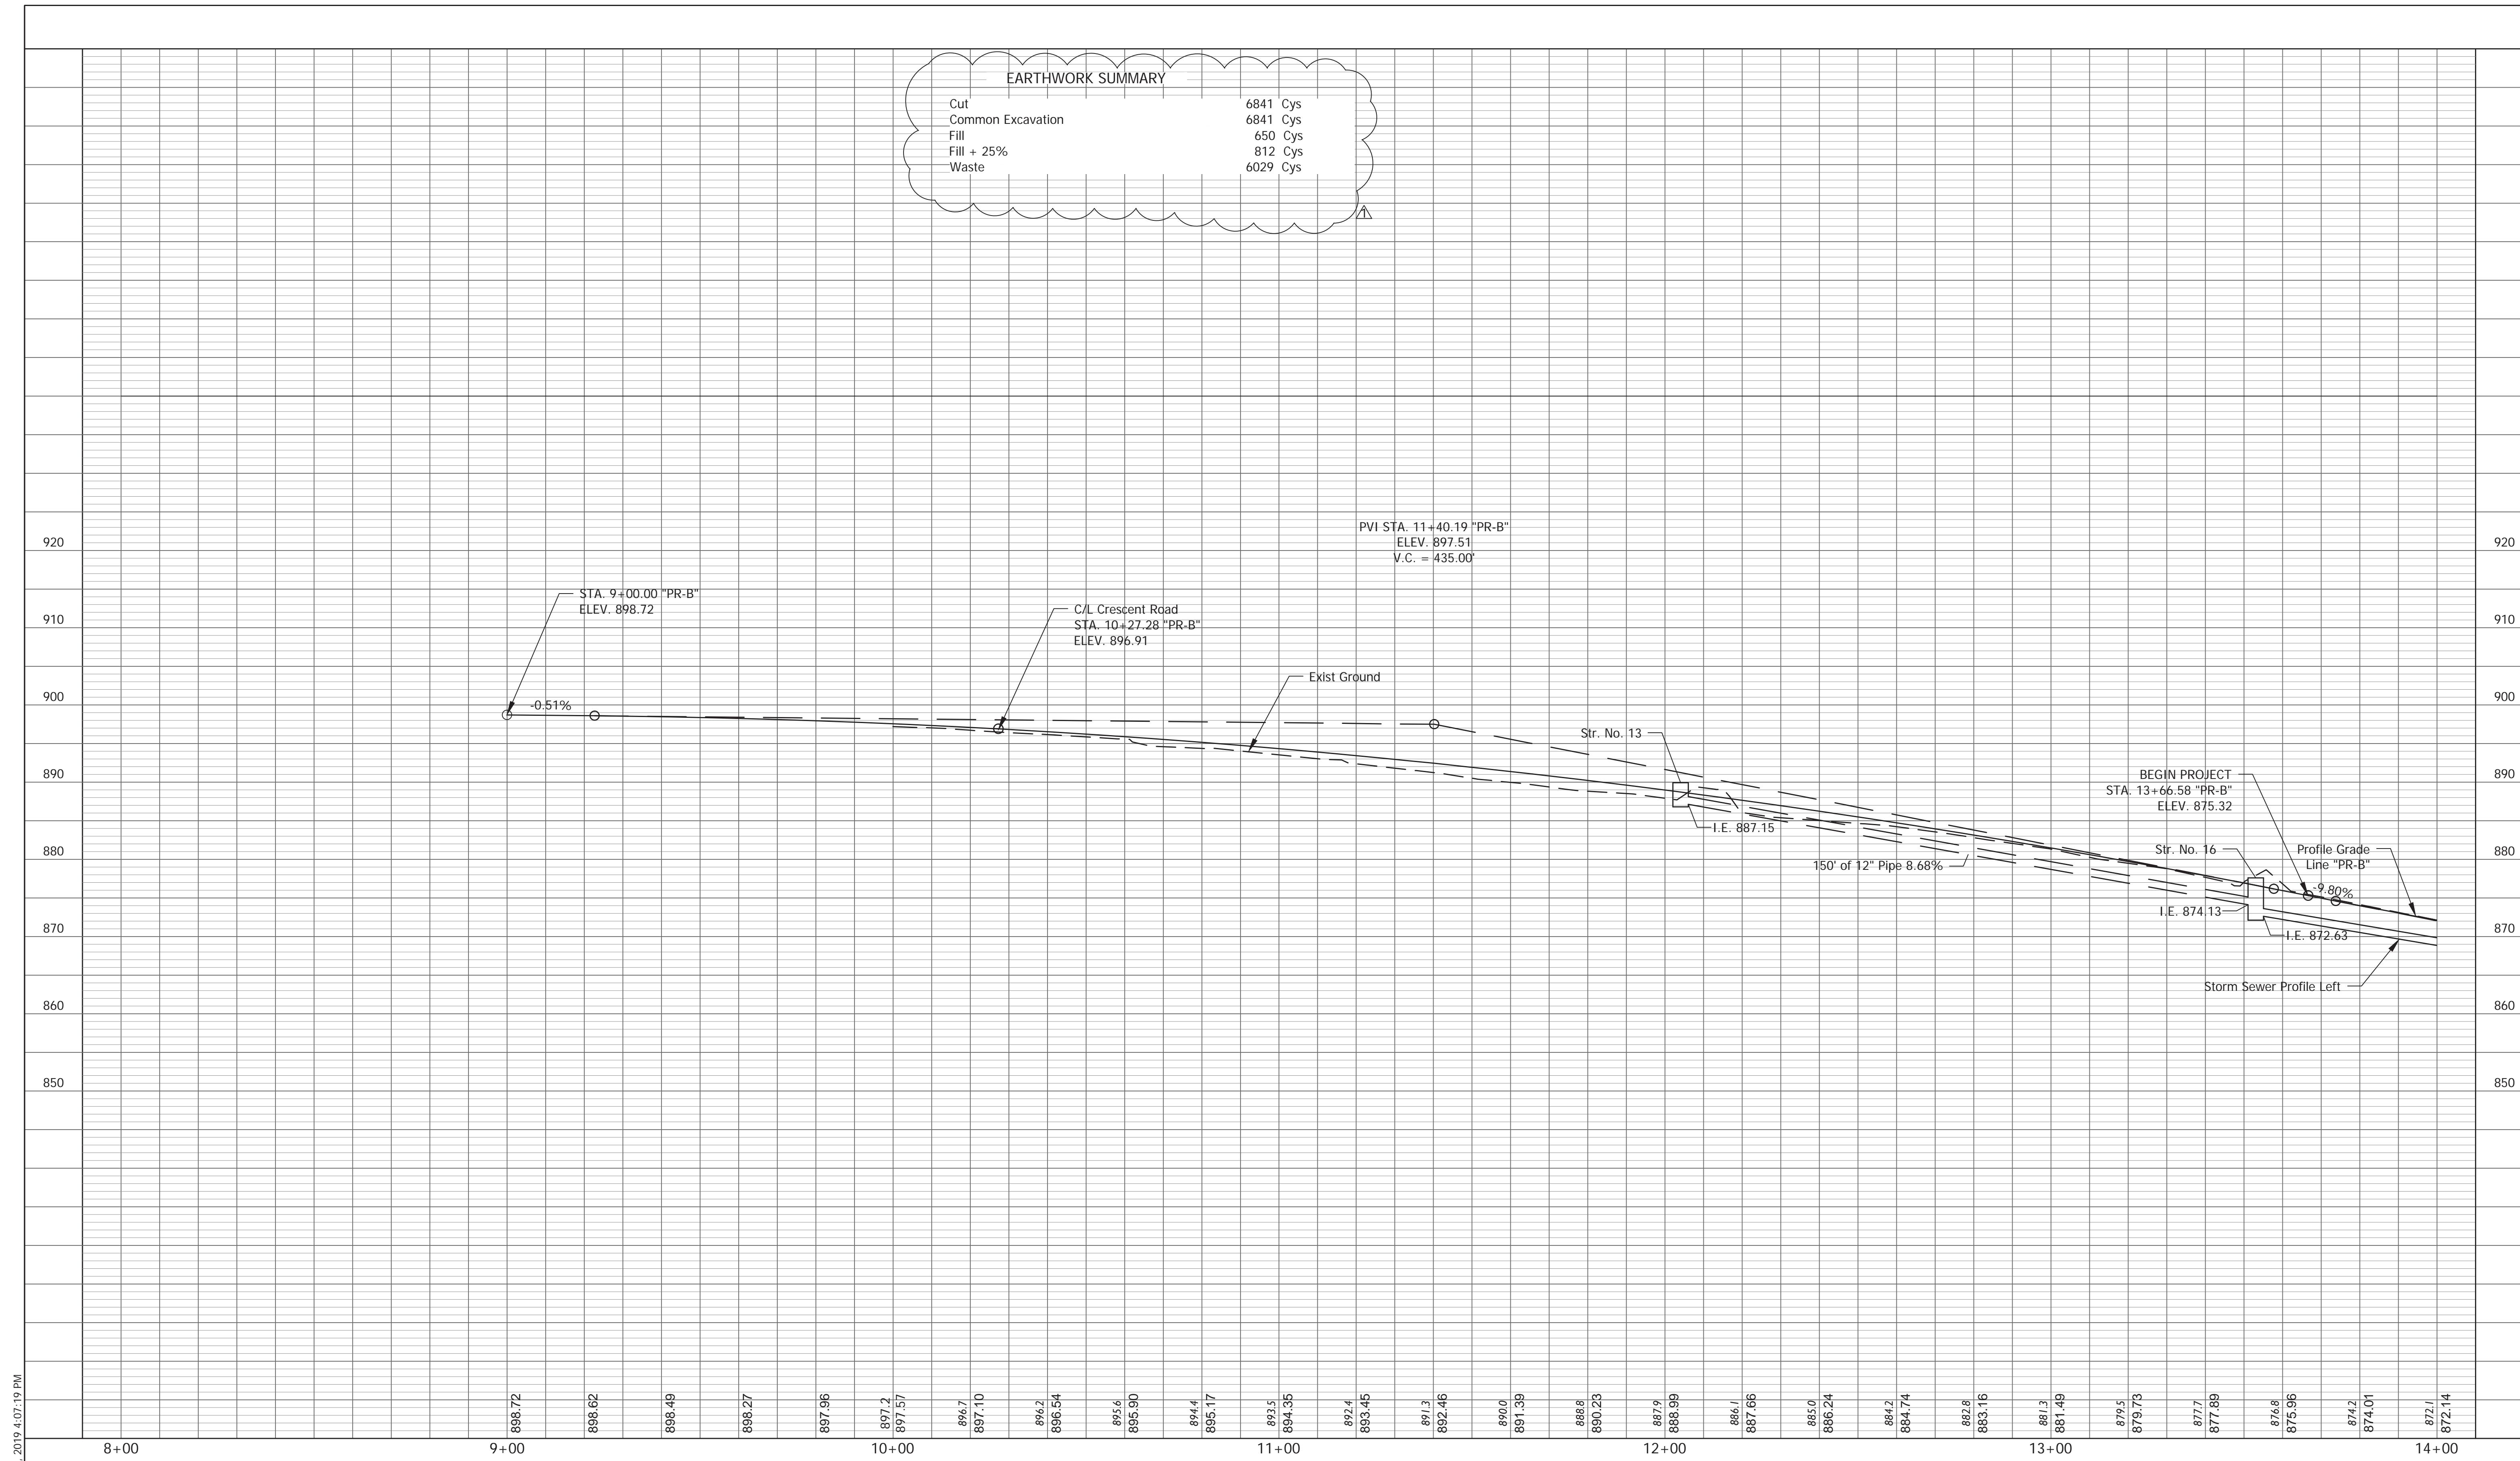


RECOMMENDED FOR APPROVAL
12/28/18
DESIGN ENGINEER DATE

DRAWN: BSF
CHECKED: LAR



DESIGNED: BSF
CHECKED: BSF

CITY OF BLOOMINGTON
PROFILE SHEET
STA. 8+00 TO STA. 14+00 - LINE "PR-B"

SCALE 1" = 20'	BRIDGE FILE N/A
VERTICAL SCALE 1" = 10'	DESIGNATION N/A
SURVEY BOOK N/A	Sheets 12 of 100
CONTRACT N/A	PROJECT 17TH STREET RECONSTRUCTION

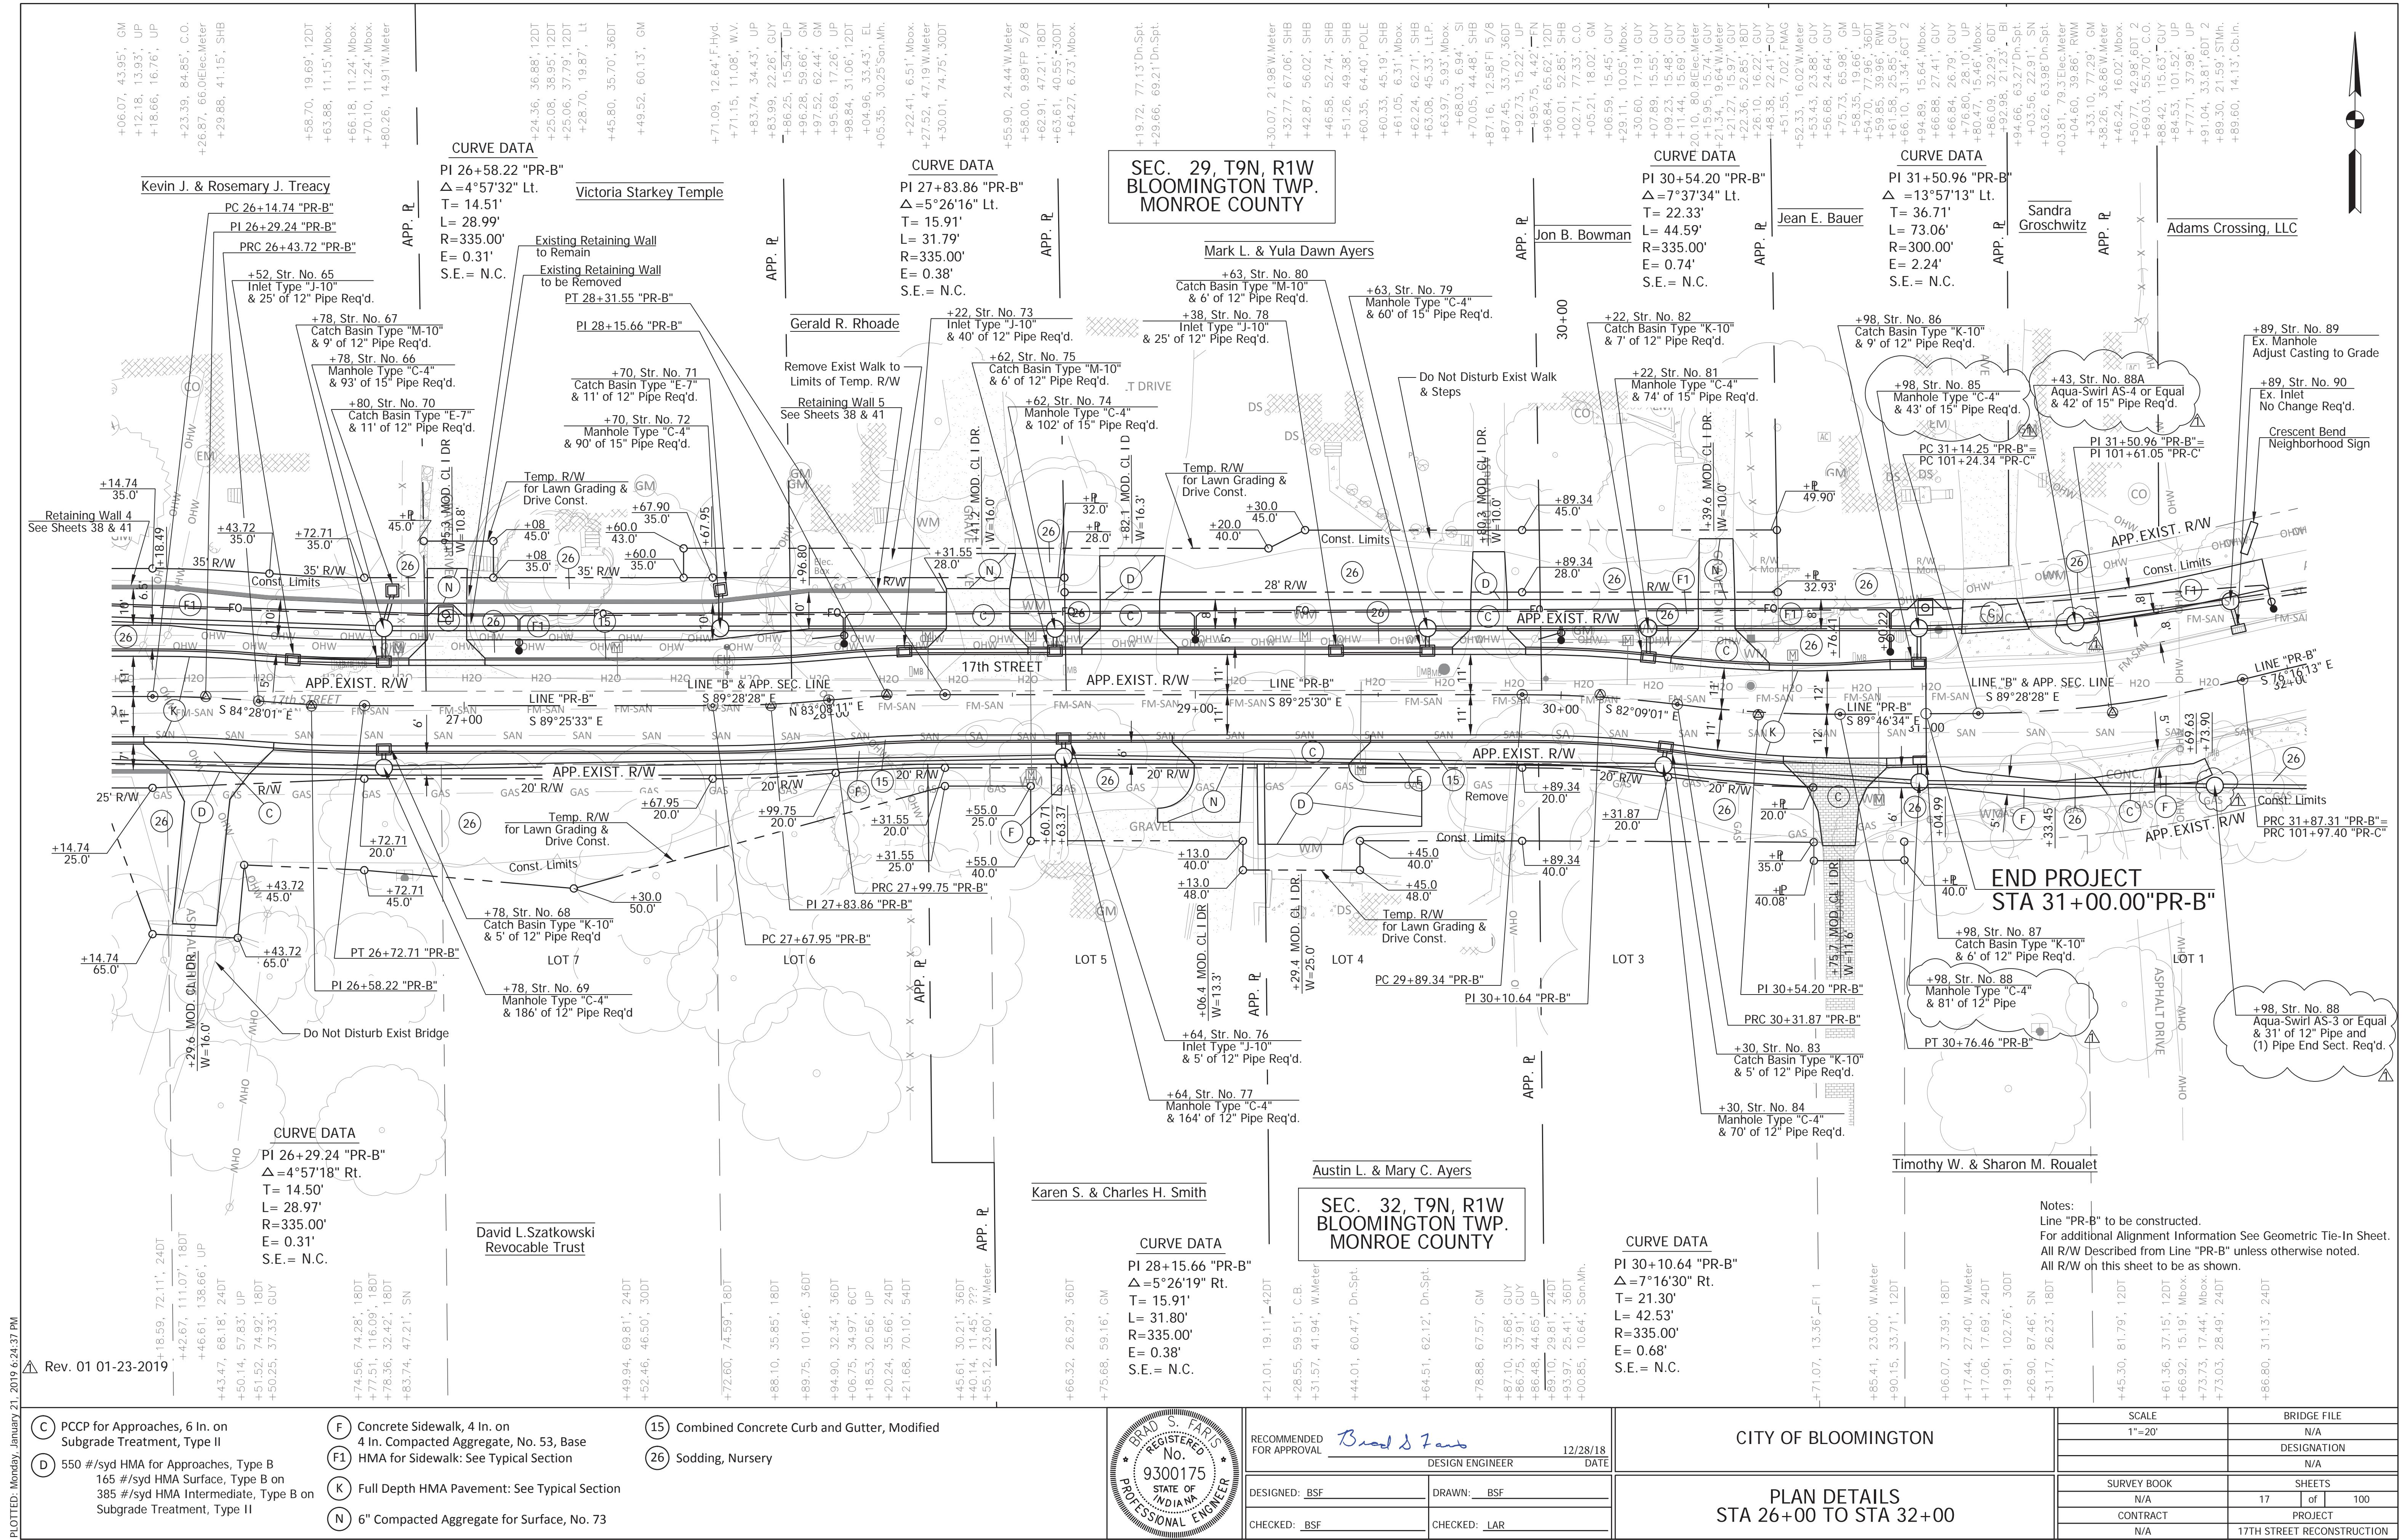

Rev. 01 01-23-2019

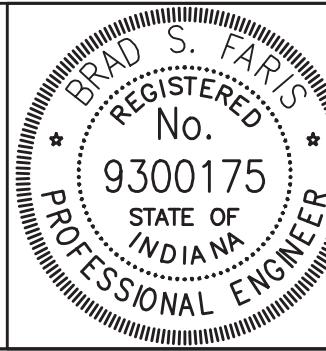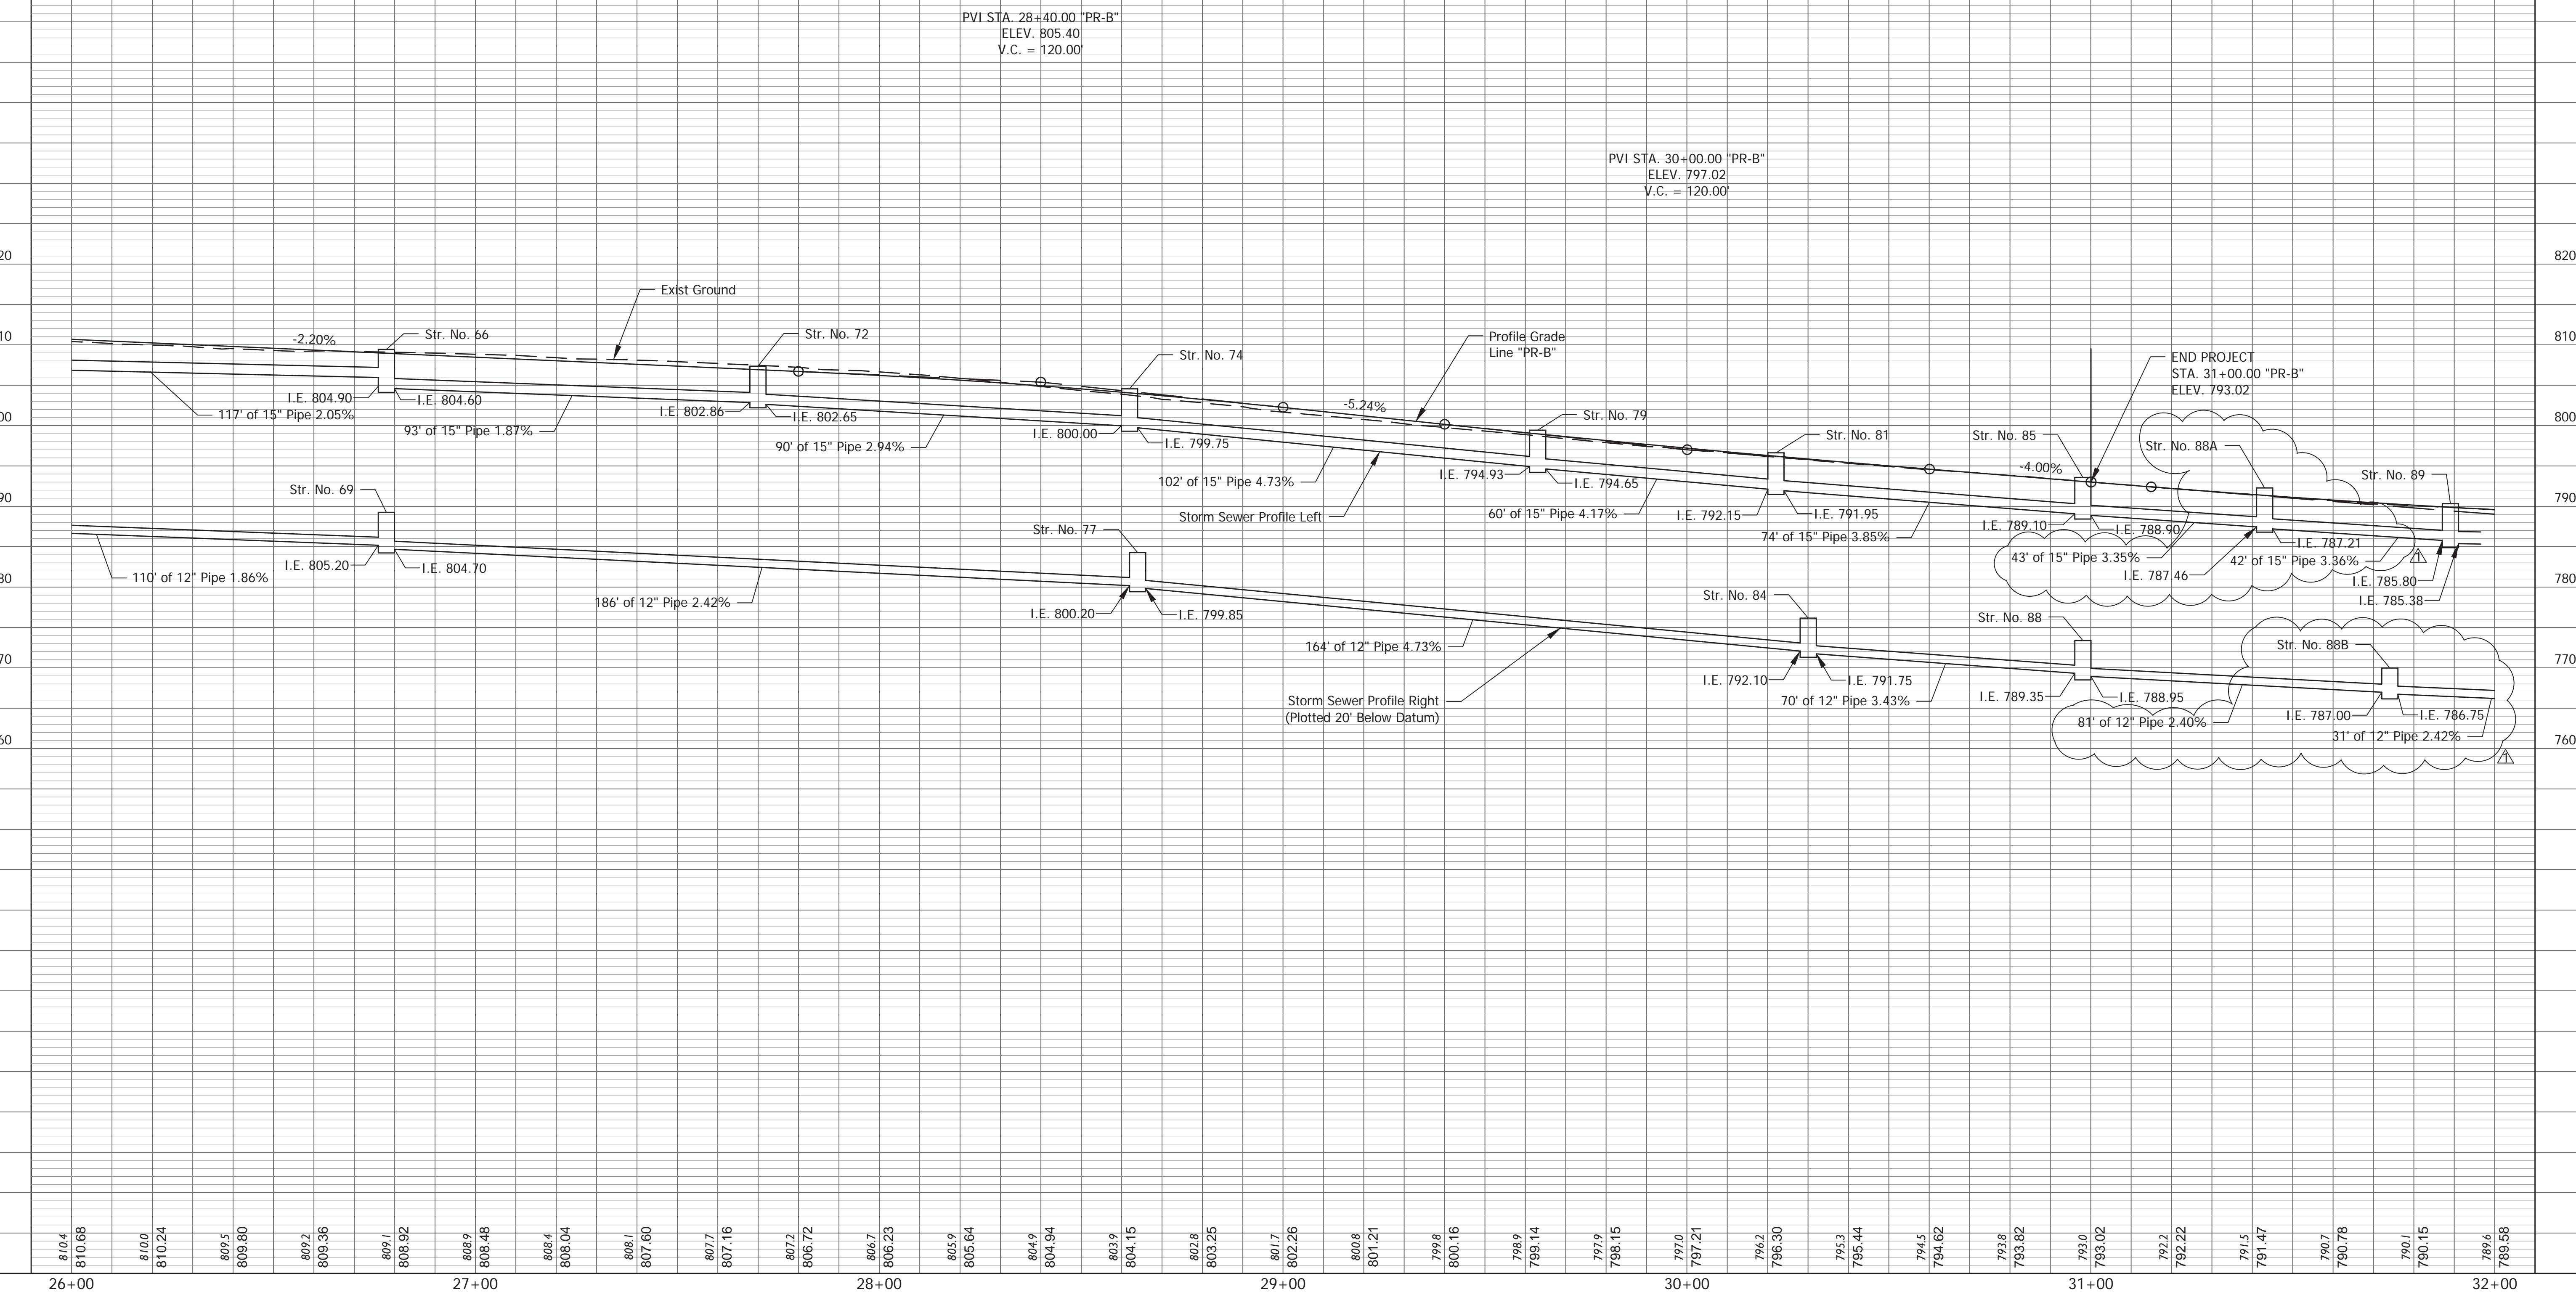

RECOMMENDED FOR APPROVAL

Brad S. Farns
12/28/18
DESIGN ENGINEER DATE

DESIGNED: BSF

DRAWN: BSF



CHECKED: BSF

CHECKED: LAR

CITY OF BLOOMINGTON

PROFILE SHEET
STA 26+00 TO STA 32+00 - LINE "PR-B"

SCALE	BRIDGE FILE
1" = 20'	N/A
VERTICAL SCALE	DESIGNATION
1" = 10'	N/A
SURVEY BOOK	Sheets
N/A	18 of 100
CONTRACT	PROJECT
N/A	17TH STREET RECONSTRUCTION

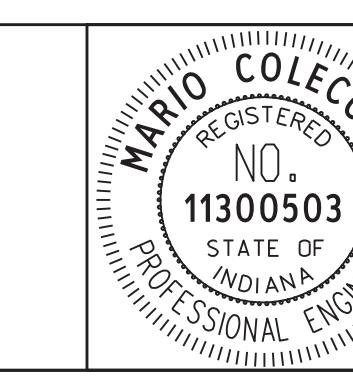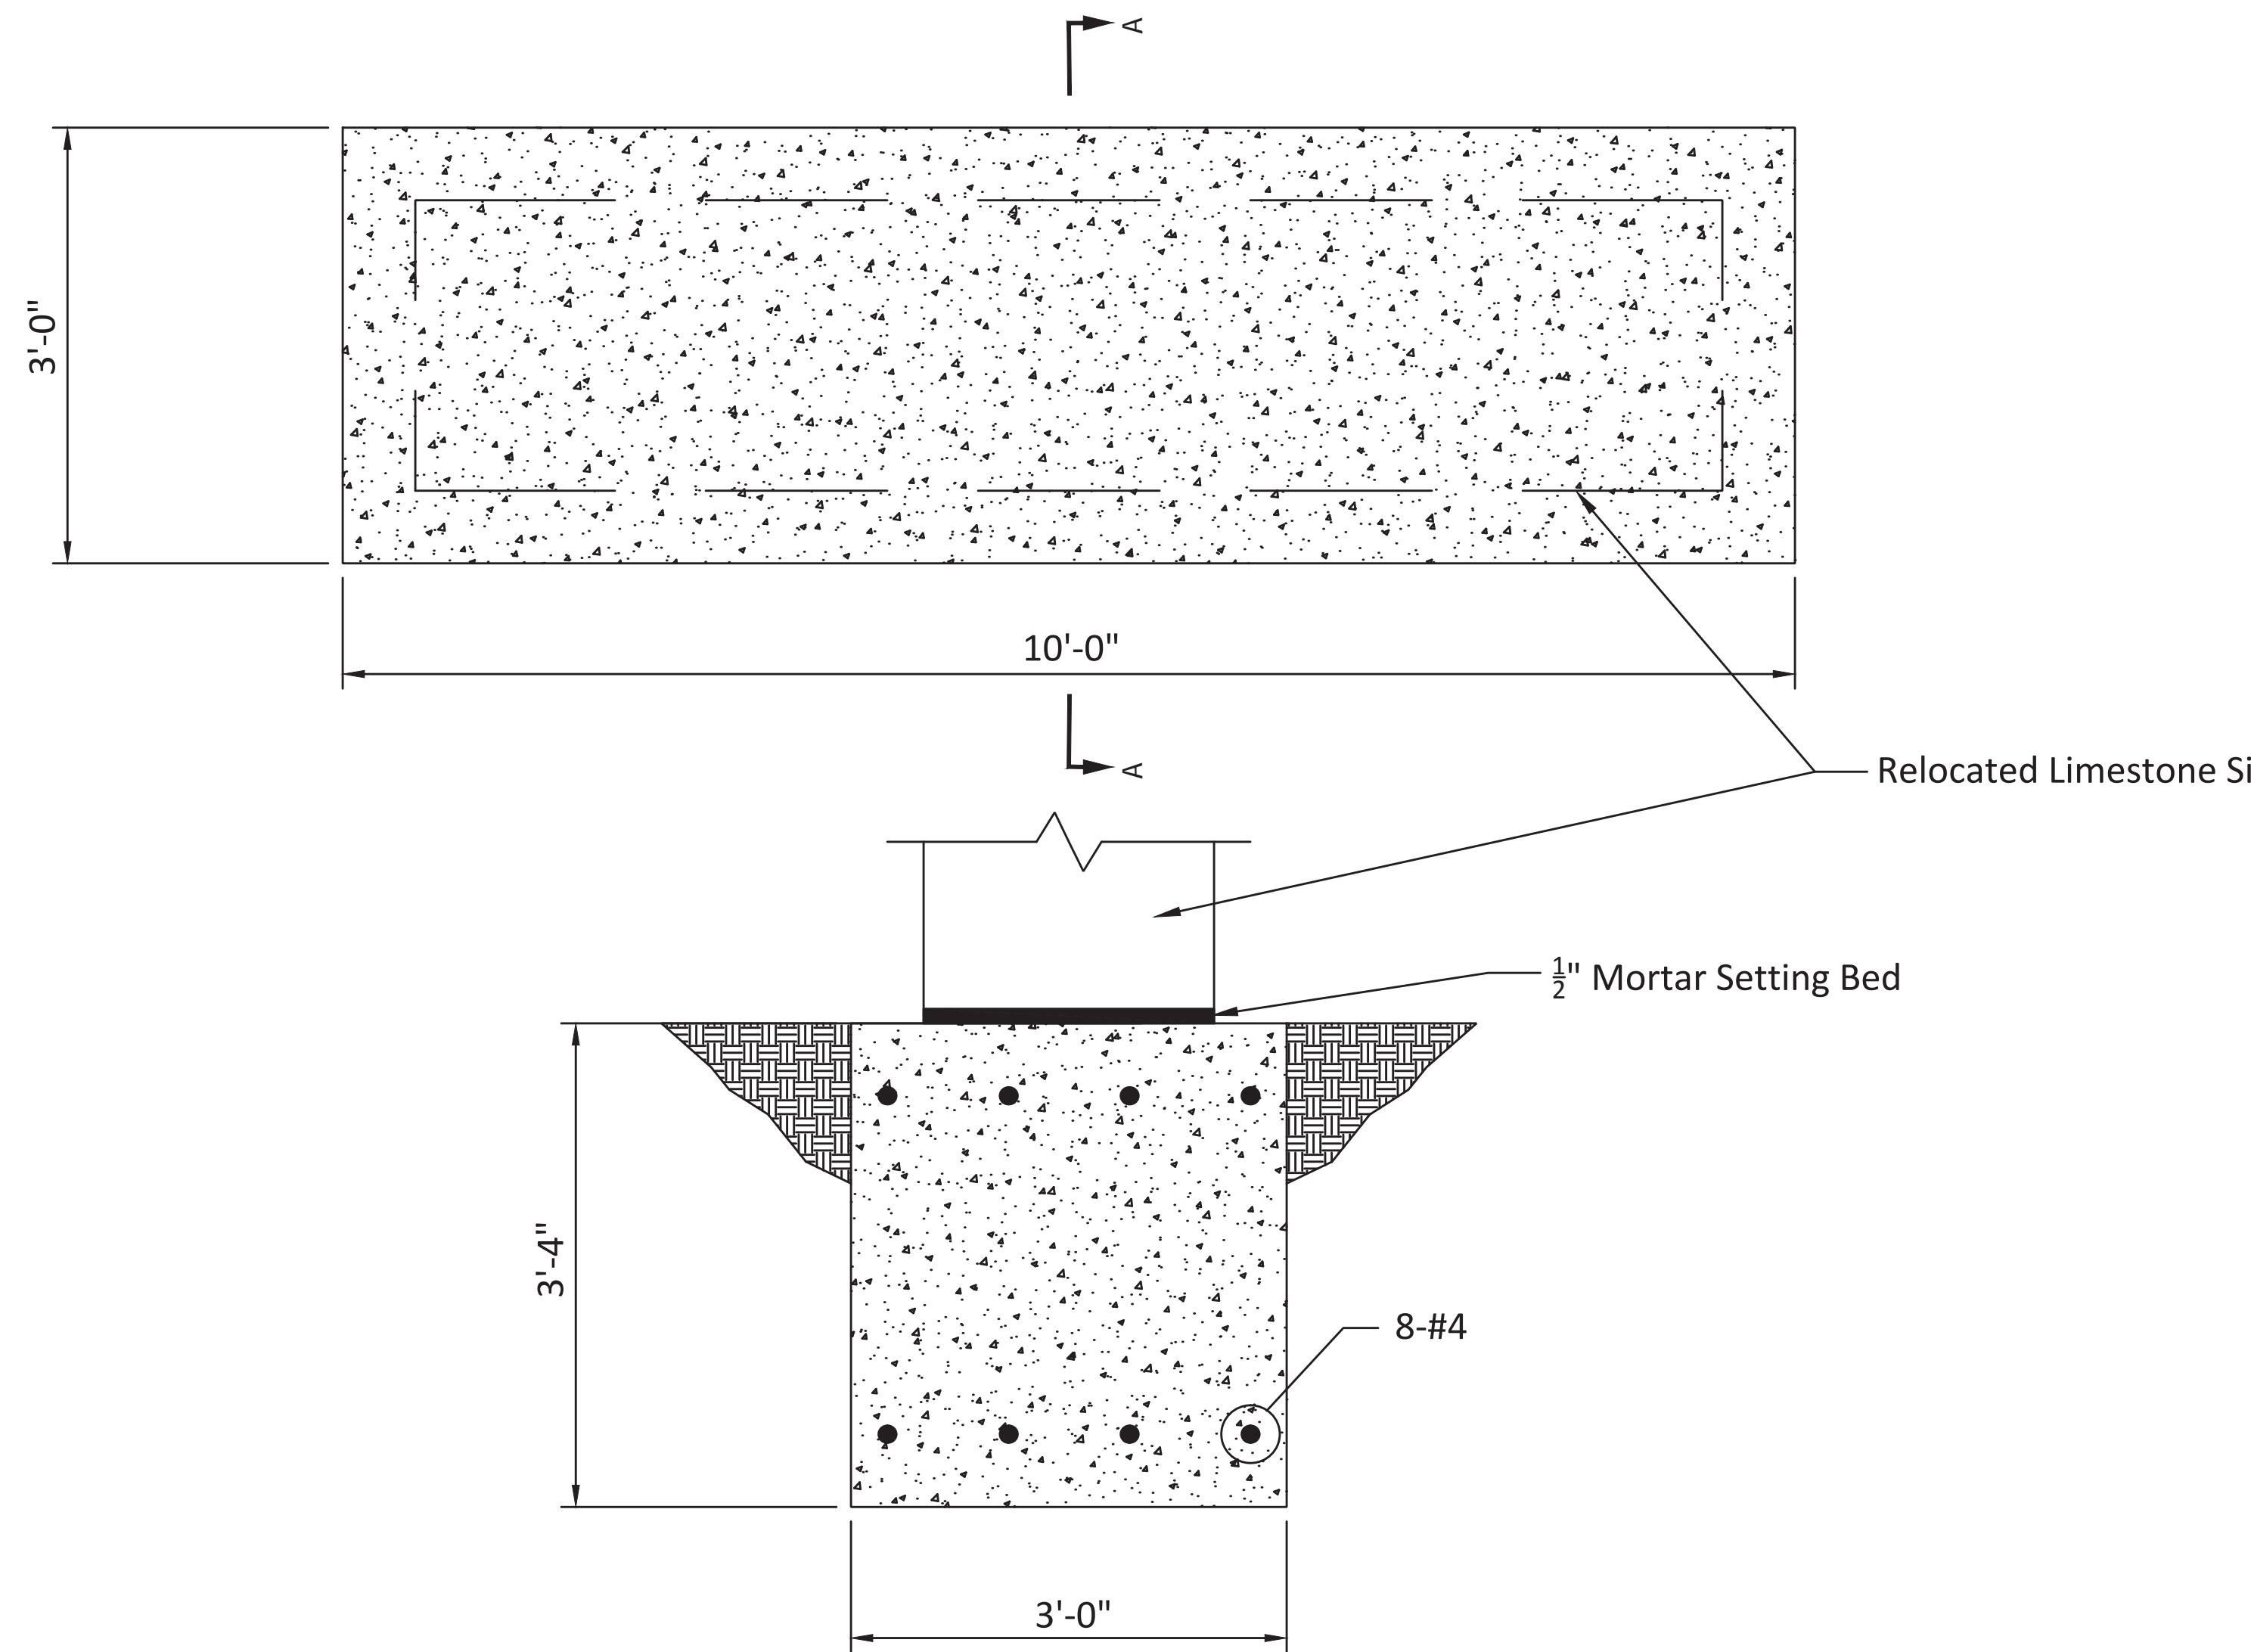

RECOMMENDED
FOR APPROVAL

M.C.
DESIGN ENGINEER

01/16/19


DATE


DESIGNED: PRD	DRAWN: PRD
CHECKED: MC	CHECKED: BSF

CITY OF BLOOMINGTON



MISCELLANEOUS DETAILS
RELOCATED SIGN FOUNDATION

SCALE	BRIDGE FILE
1"=1'	N/A
	DESIGNATION
	N/A
SURVEY BOOK	SHEETS
N/A	41-1 of 100
CONTRACT	PROJECT
N/A	17TH STREET RECONSTRUCTION

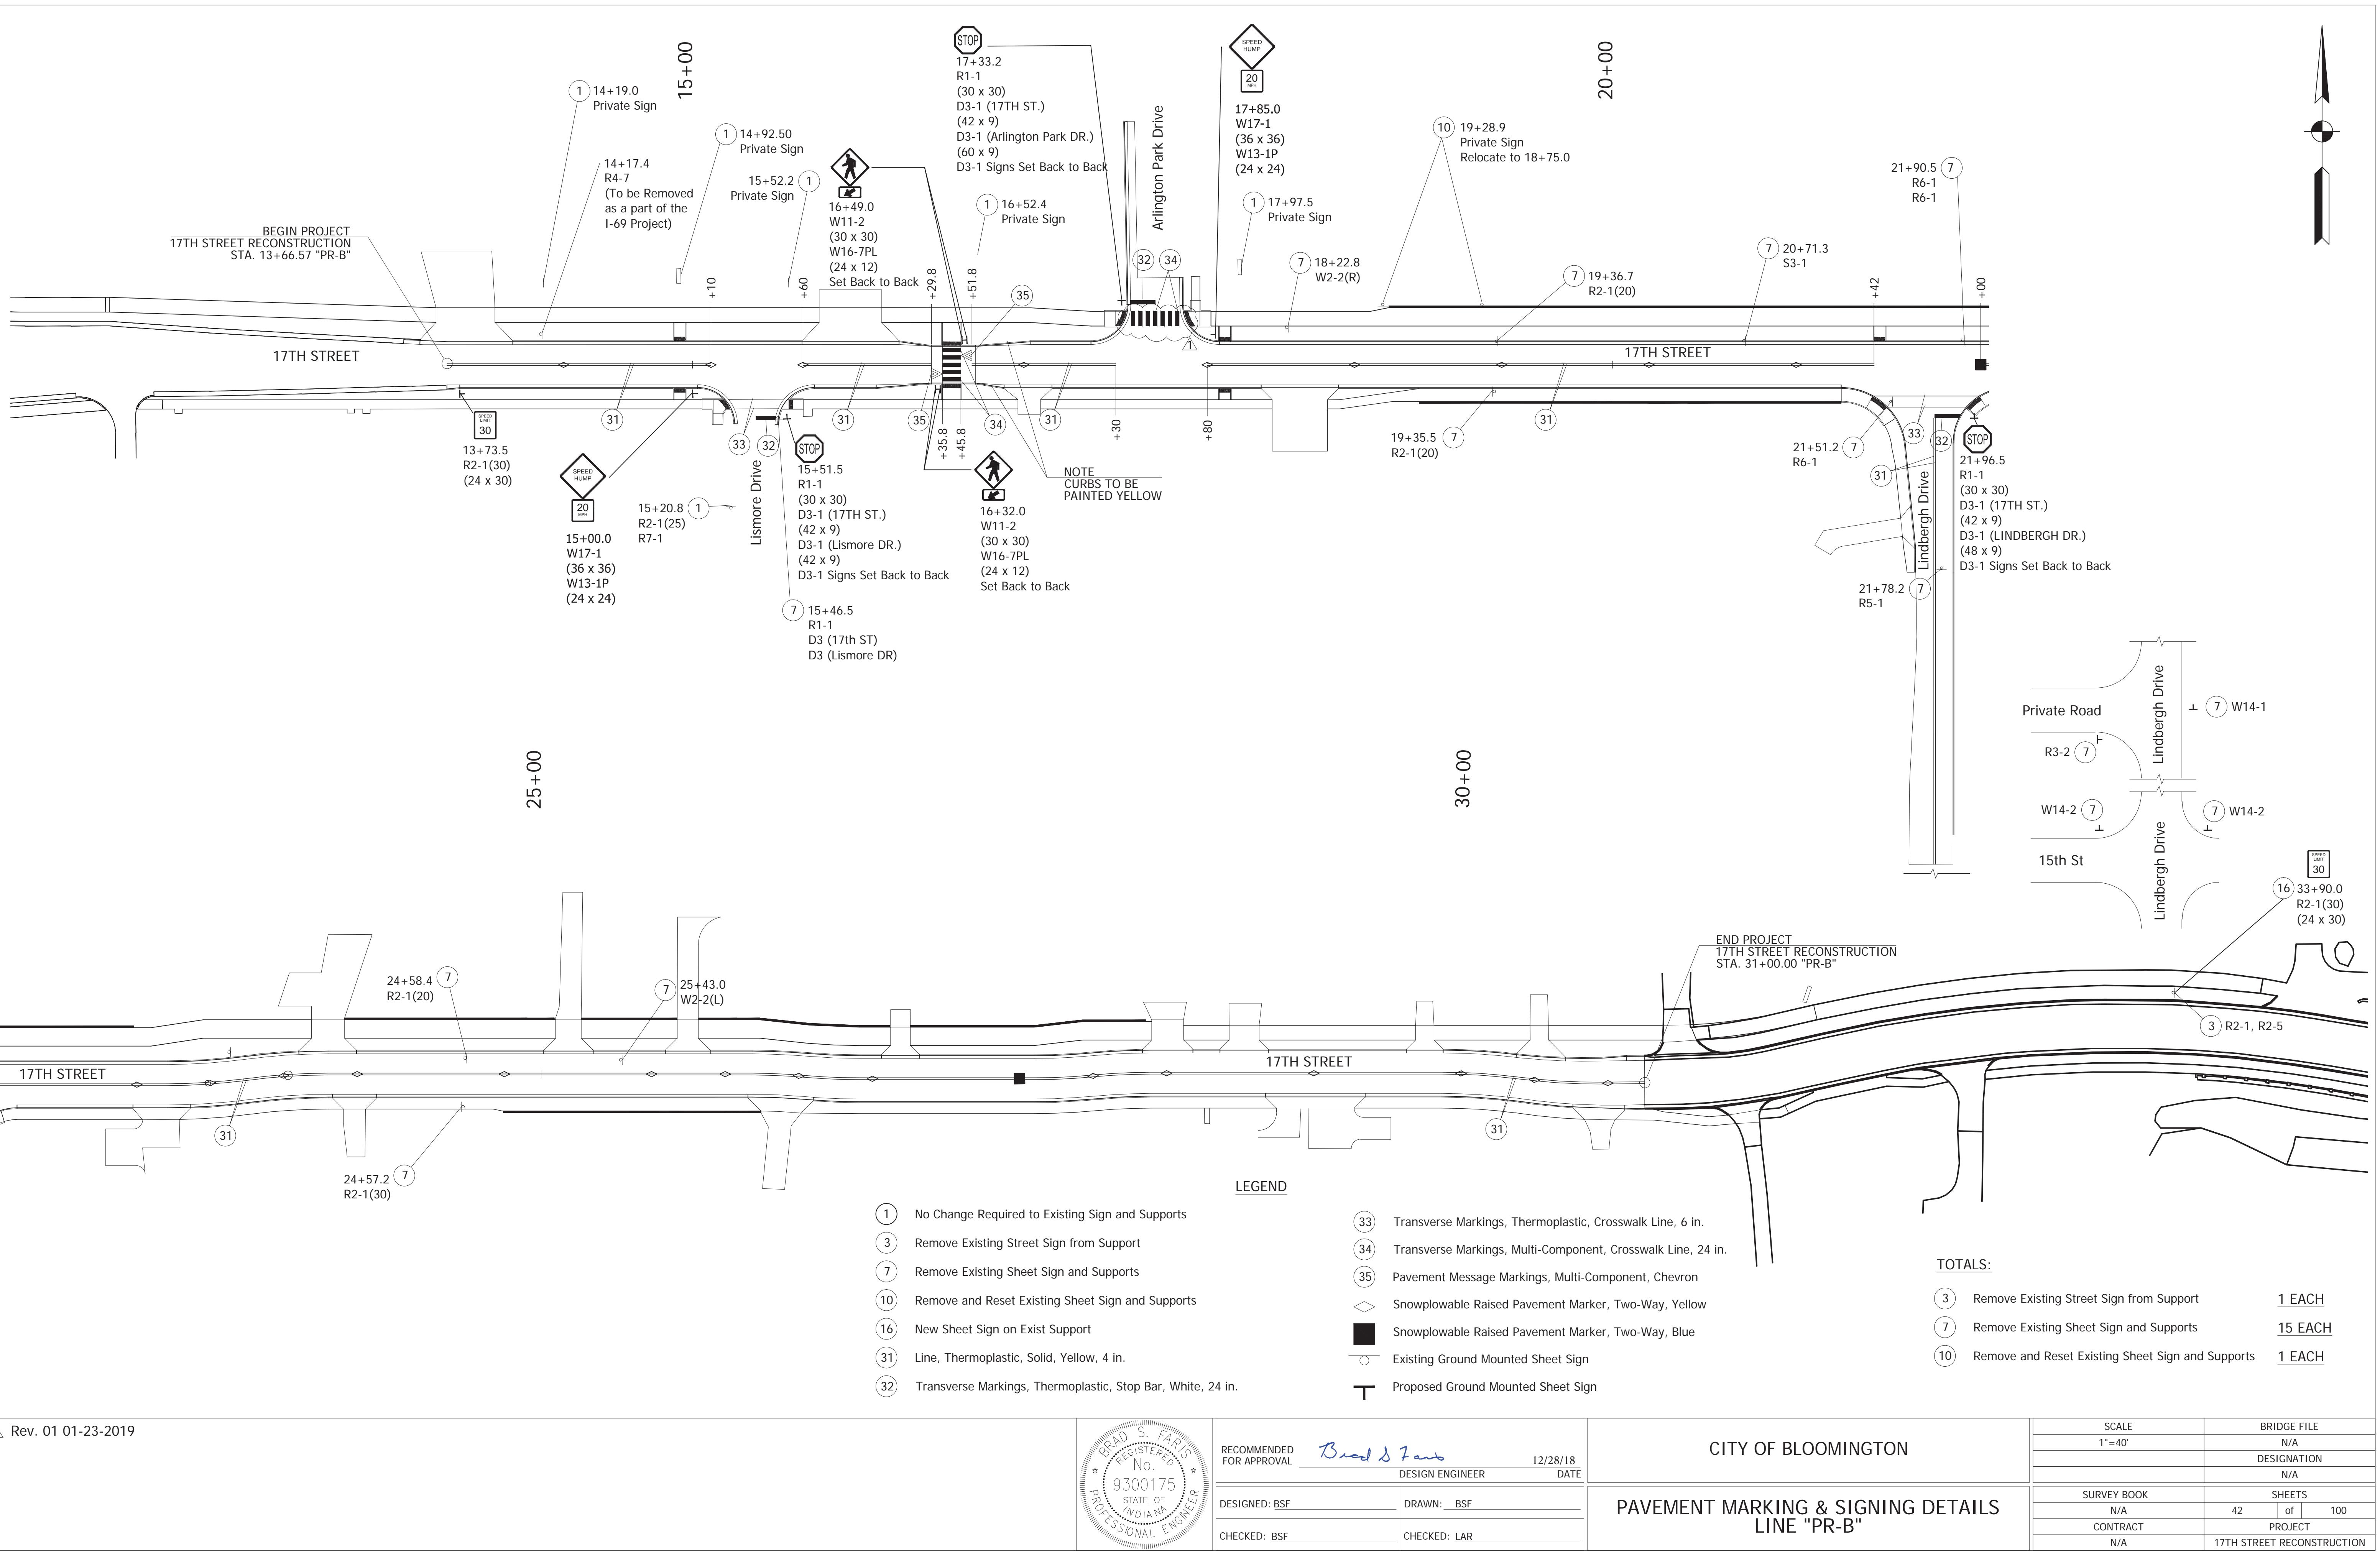

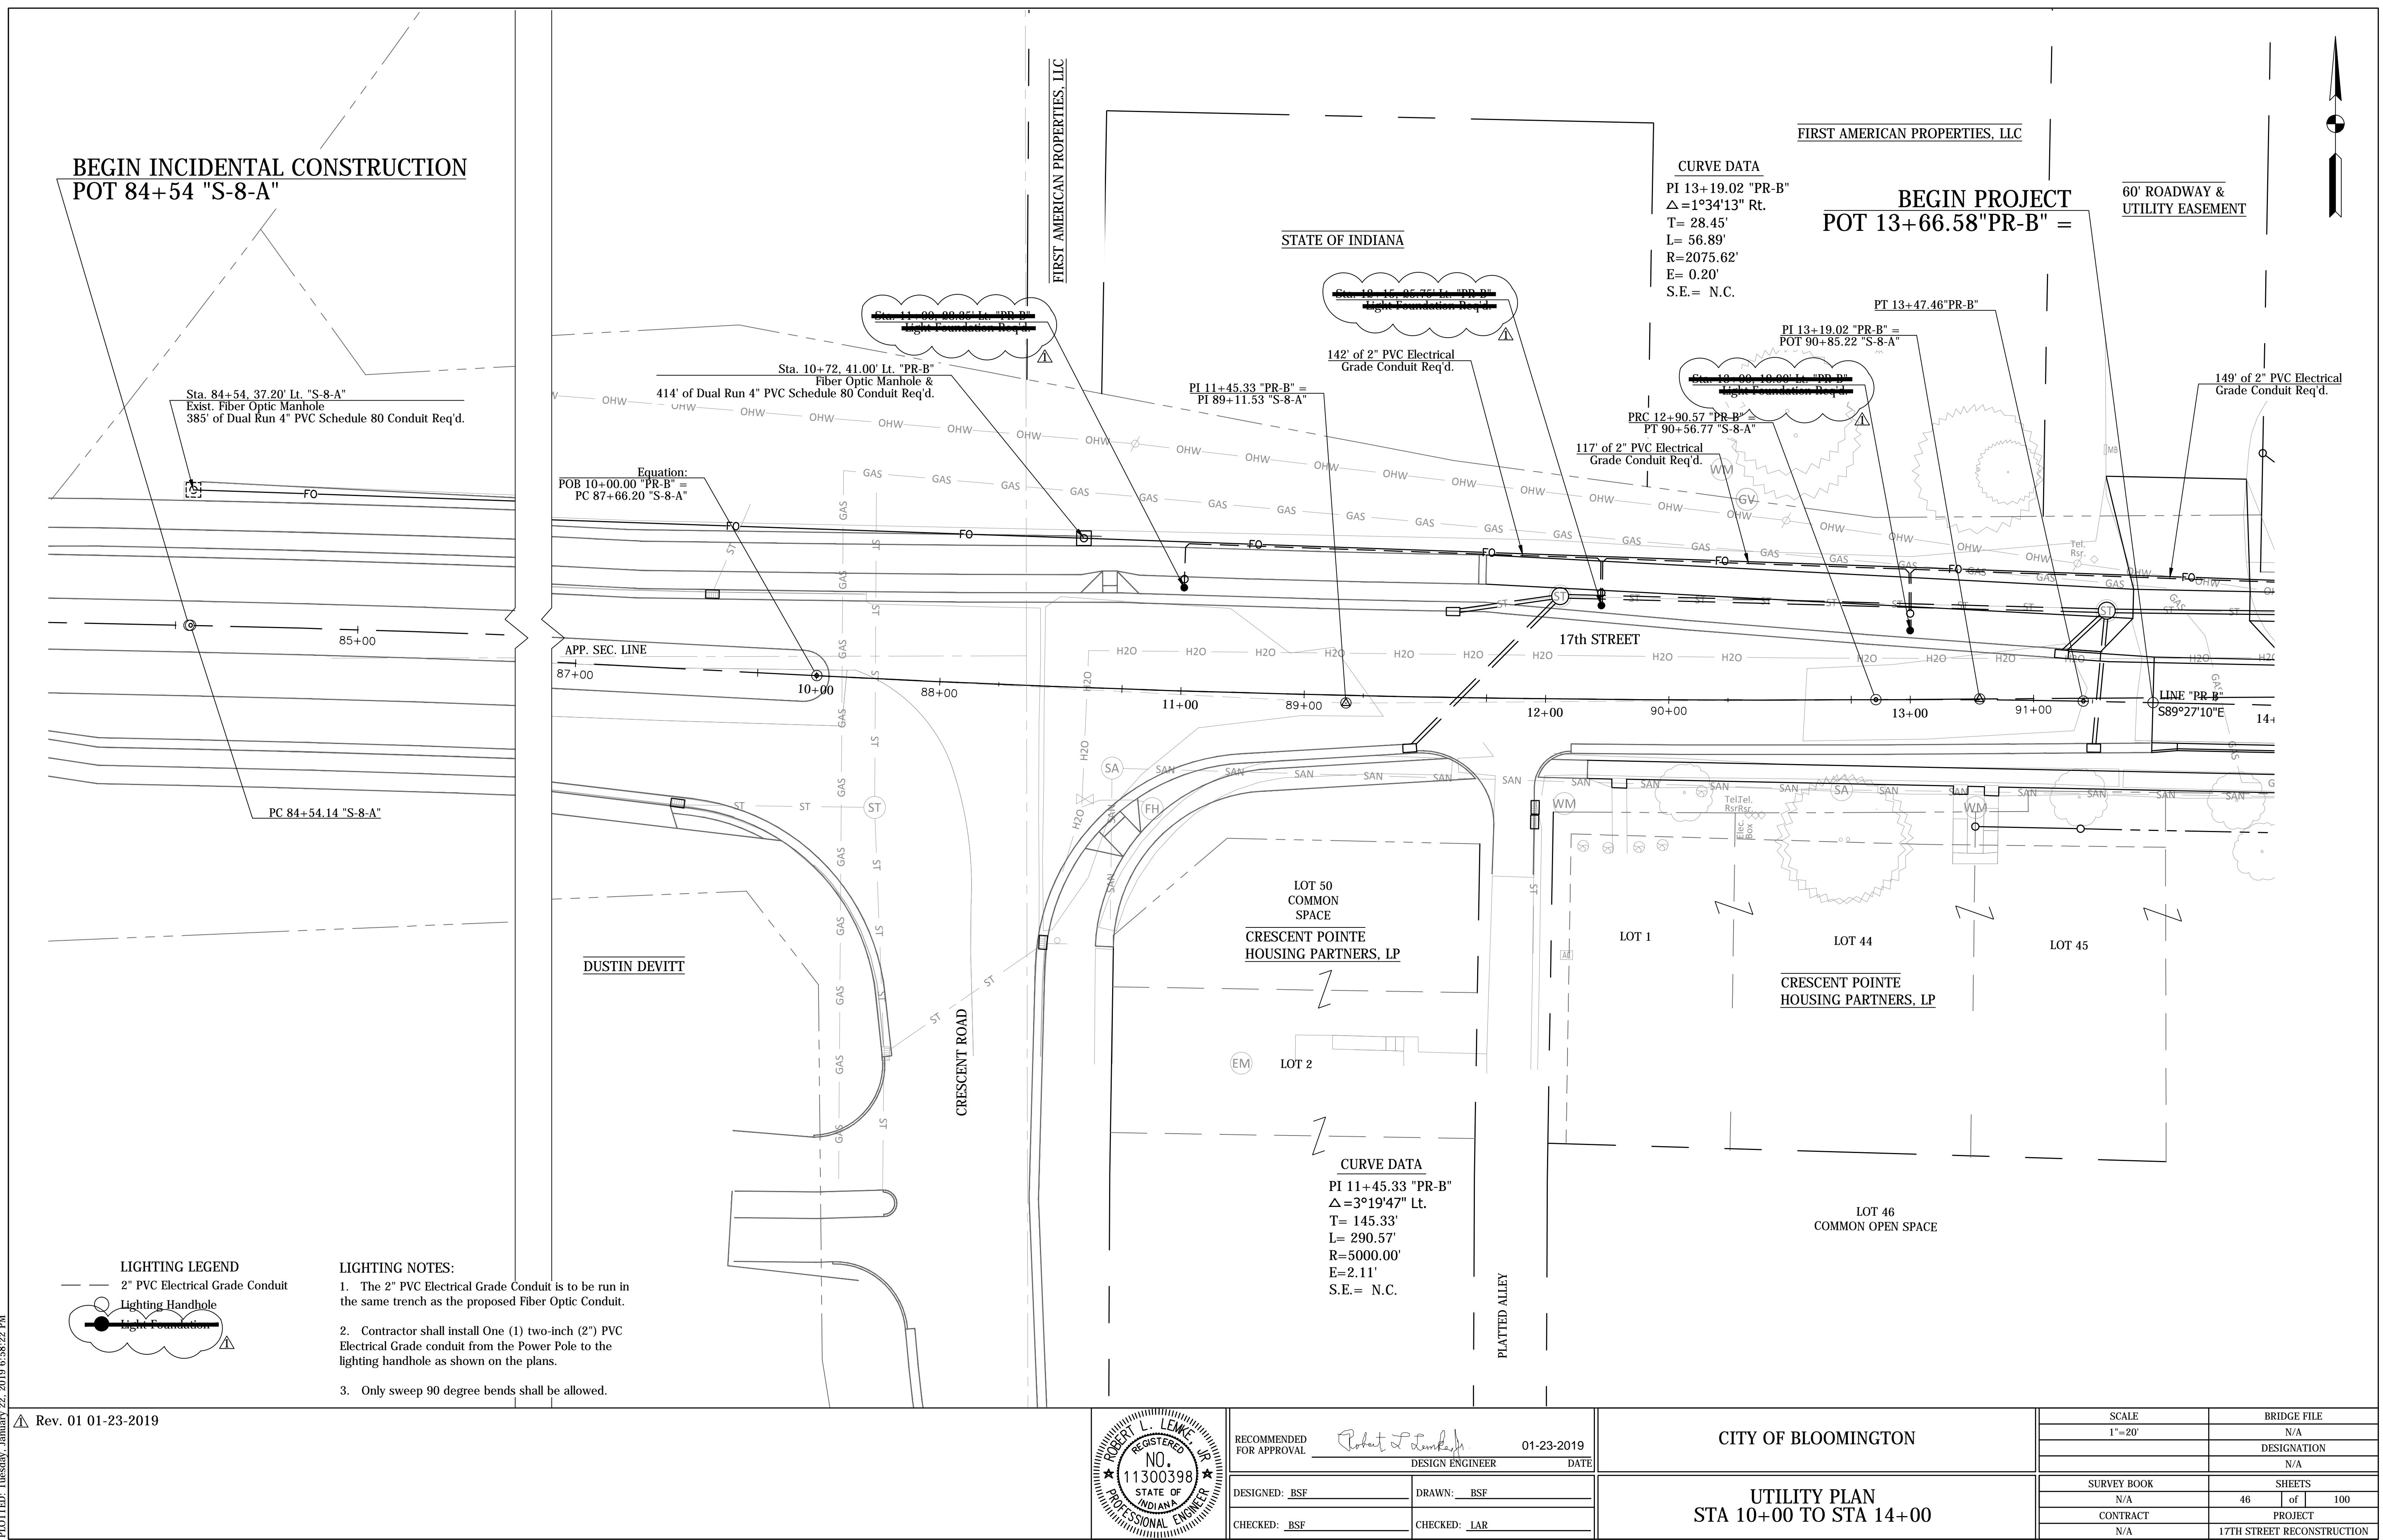

MATCH LINE STA. 20+00

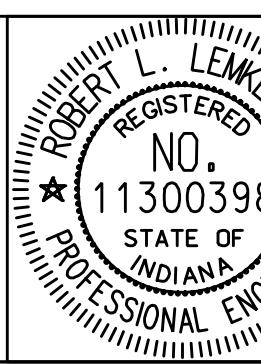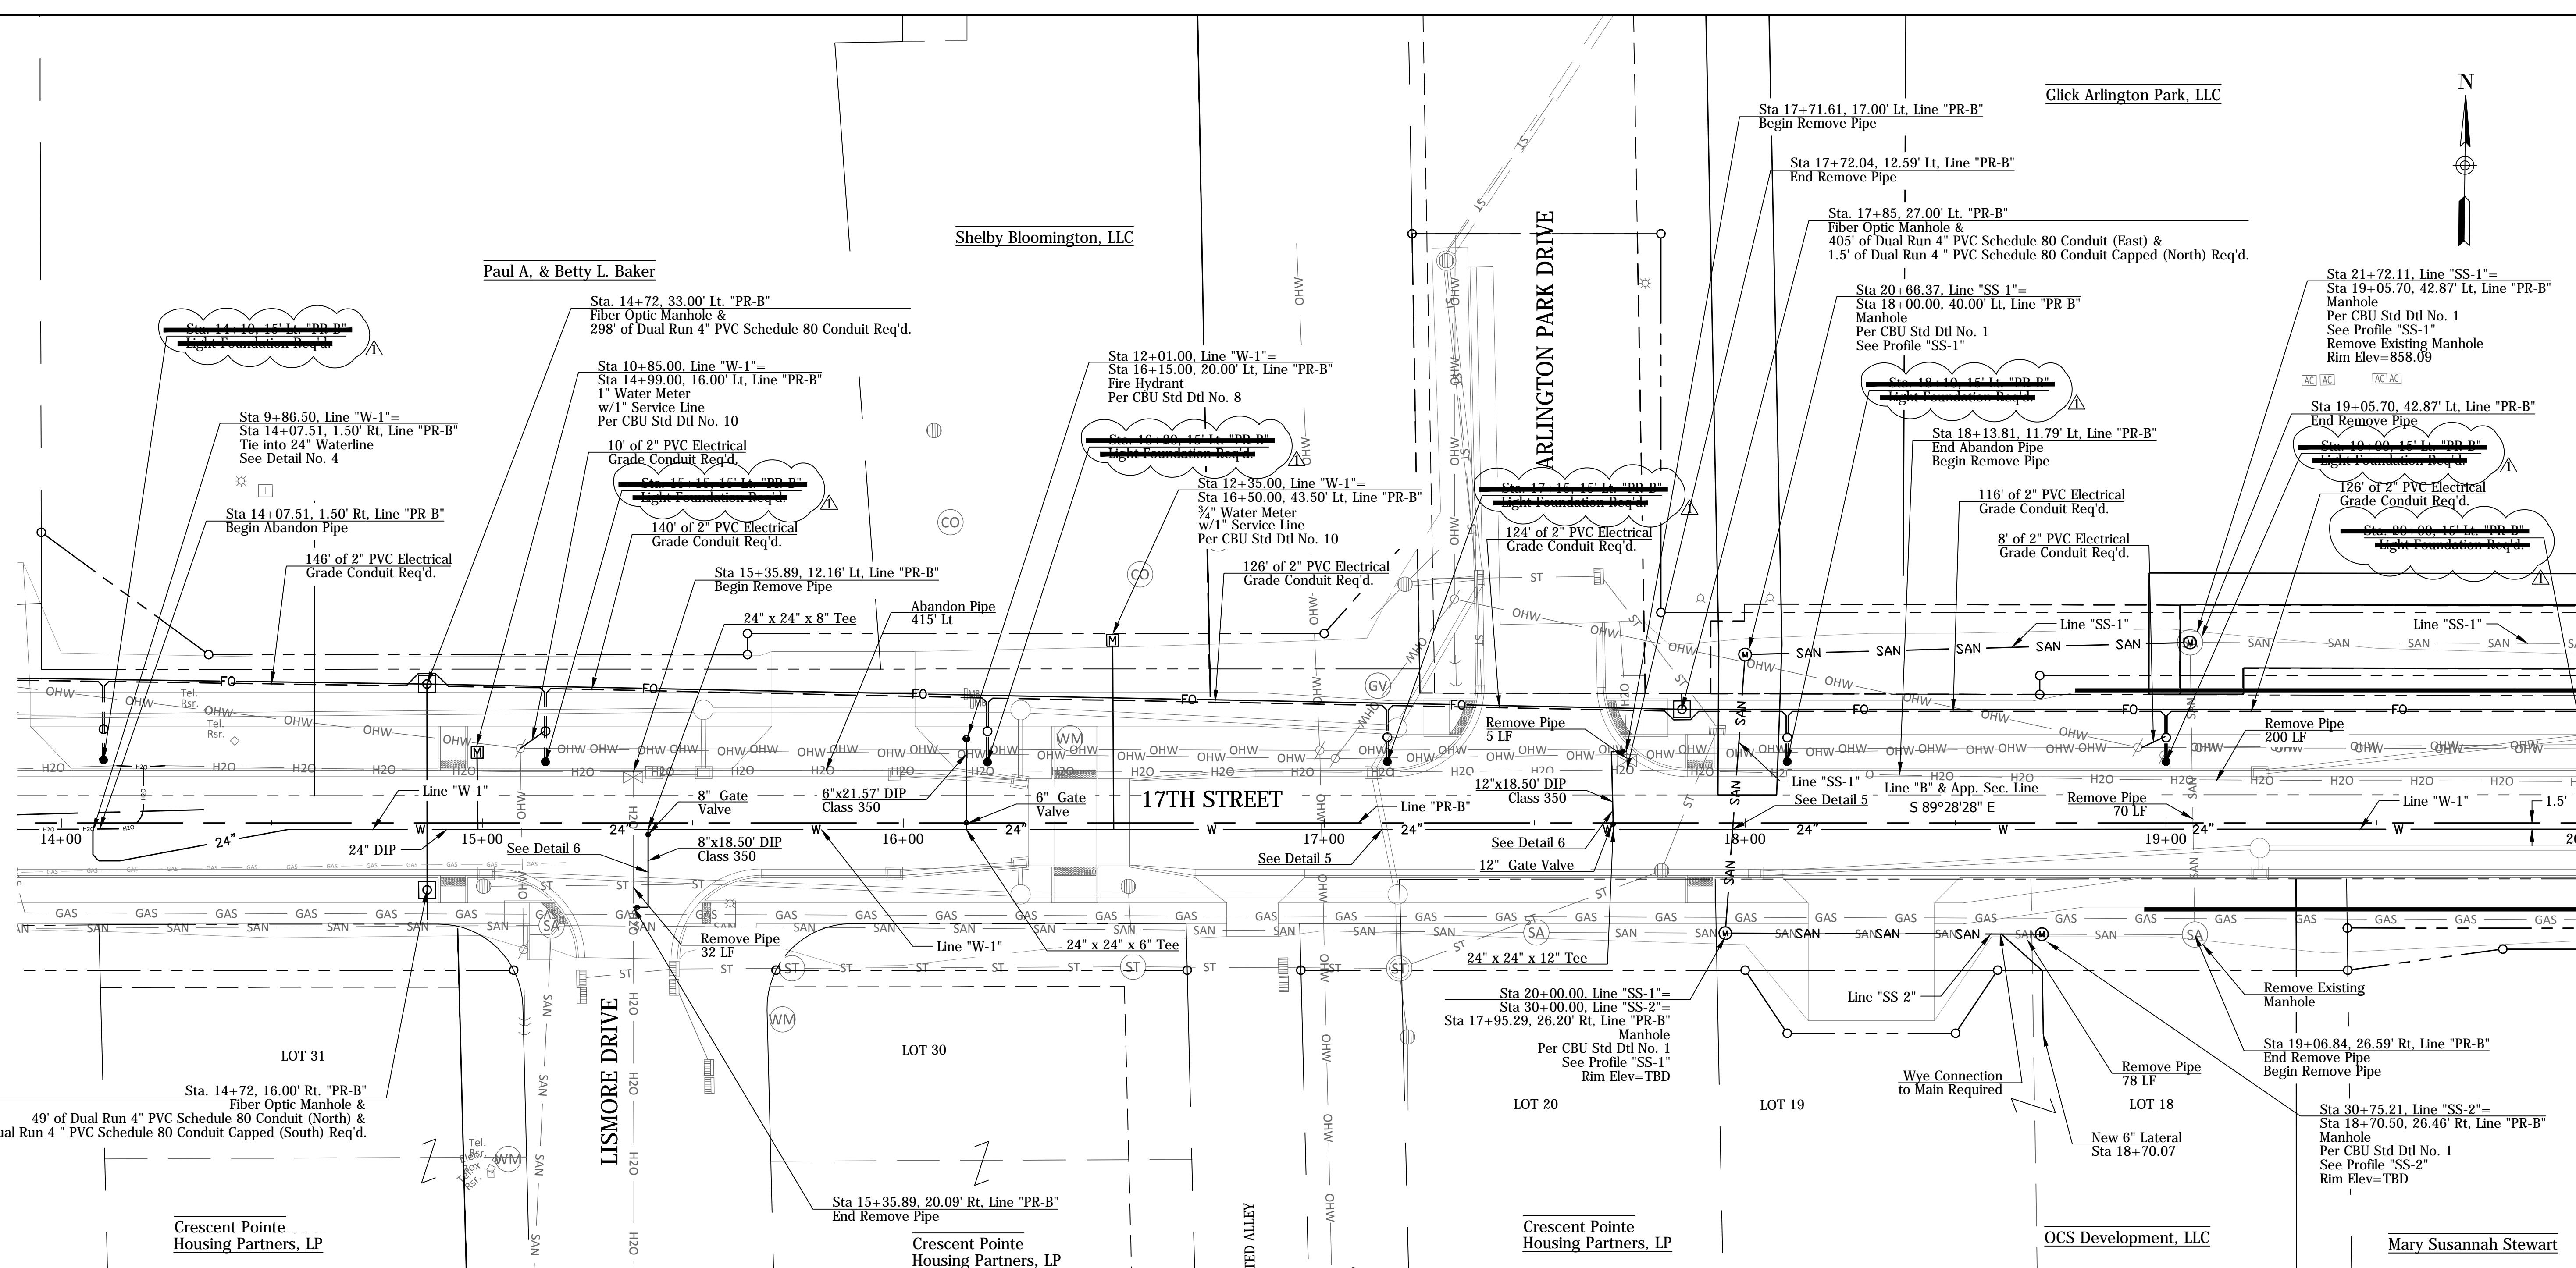

RECOMMENDED FOR APPROVAL

DESIGNED: LTM

CHECKED: GAG

01-23-2019

DRAWN: CDF

CHECKED: LTM

DESIGN ENGINEER

DATE

RECOMMENDED FOR APPROVAL


01-23-2019

DESIGN ENGINEER

DATE

CITY OF BLOOMINGTON
UTILITY PLAN
STA 14+00 TO STA 20+00

SCALE	BRIDGE FILE
1"=20'	N/A
DESIGNATION	N/A
SURVEY BOOK	SHEETS
N/A	47 of 100
CONTRACT	PROJECT
N/A	17TH STREET RECONSTRUCTION

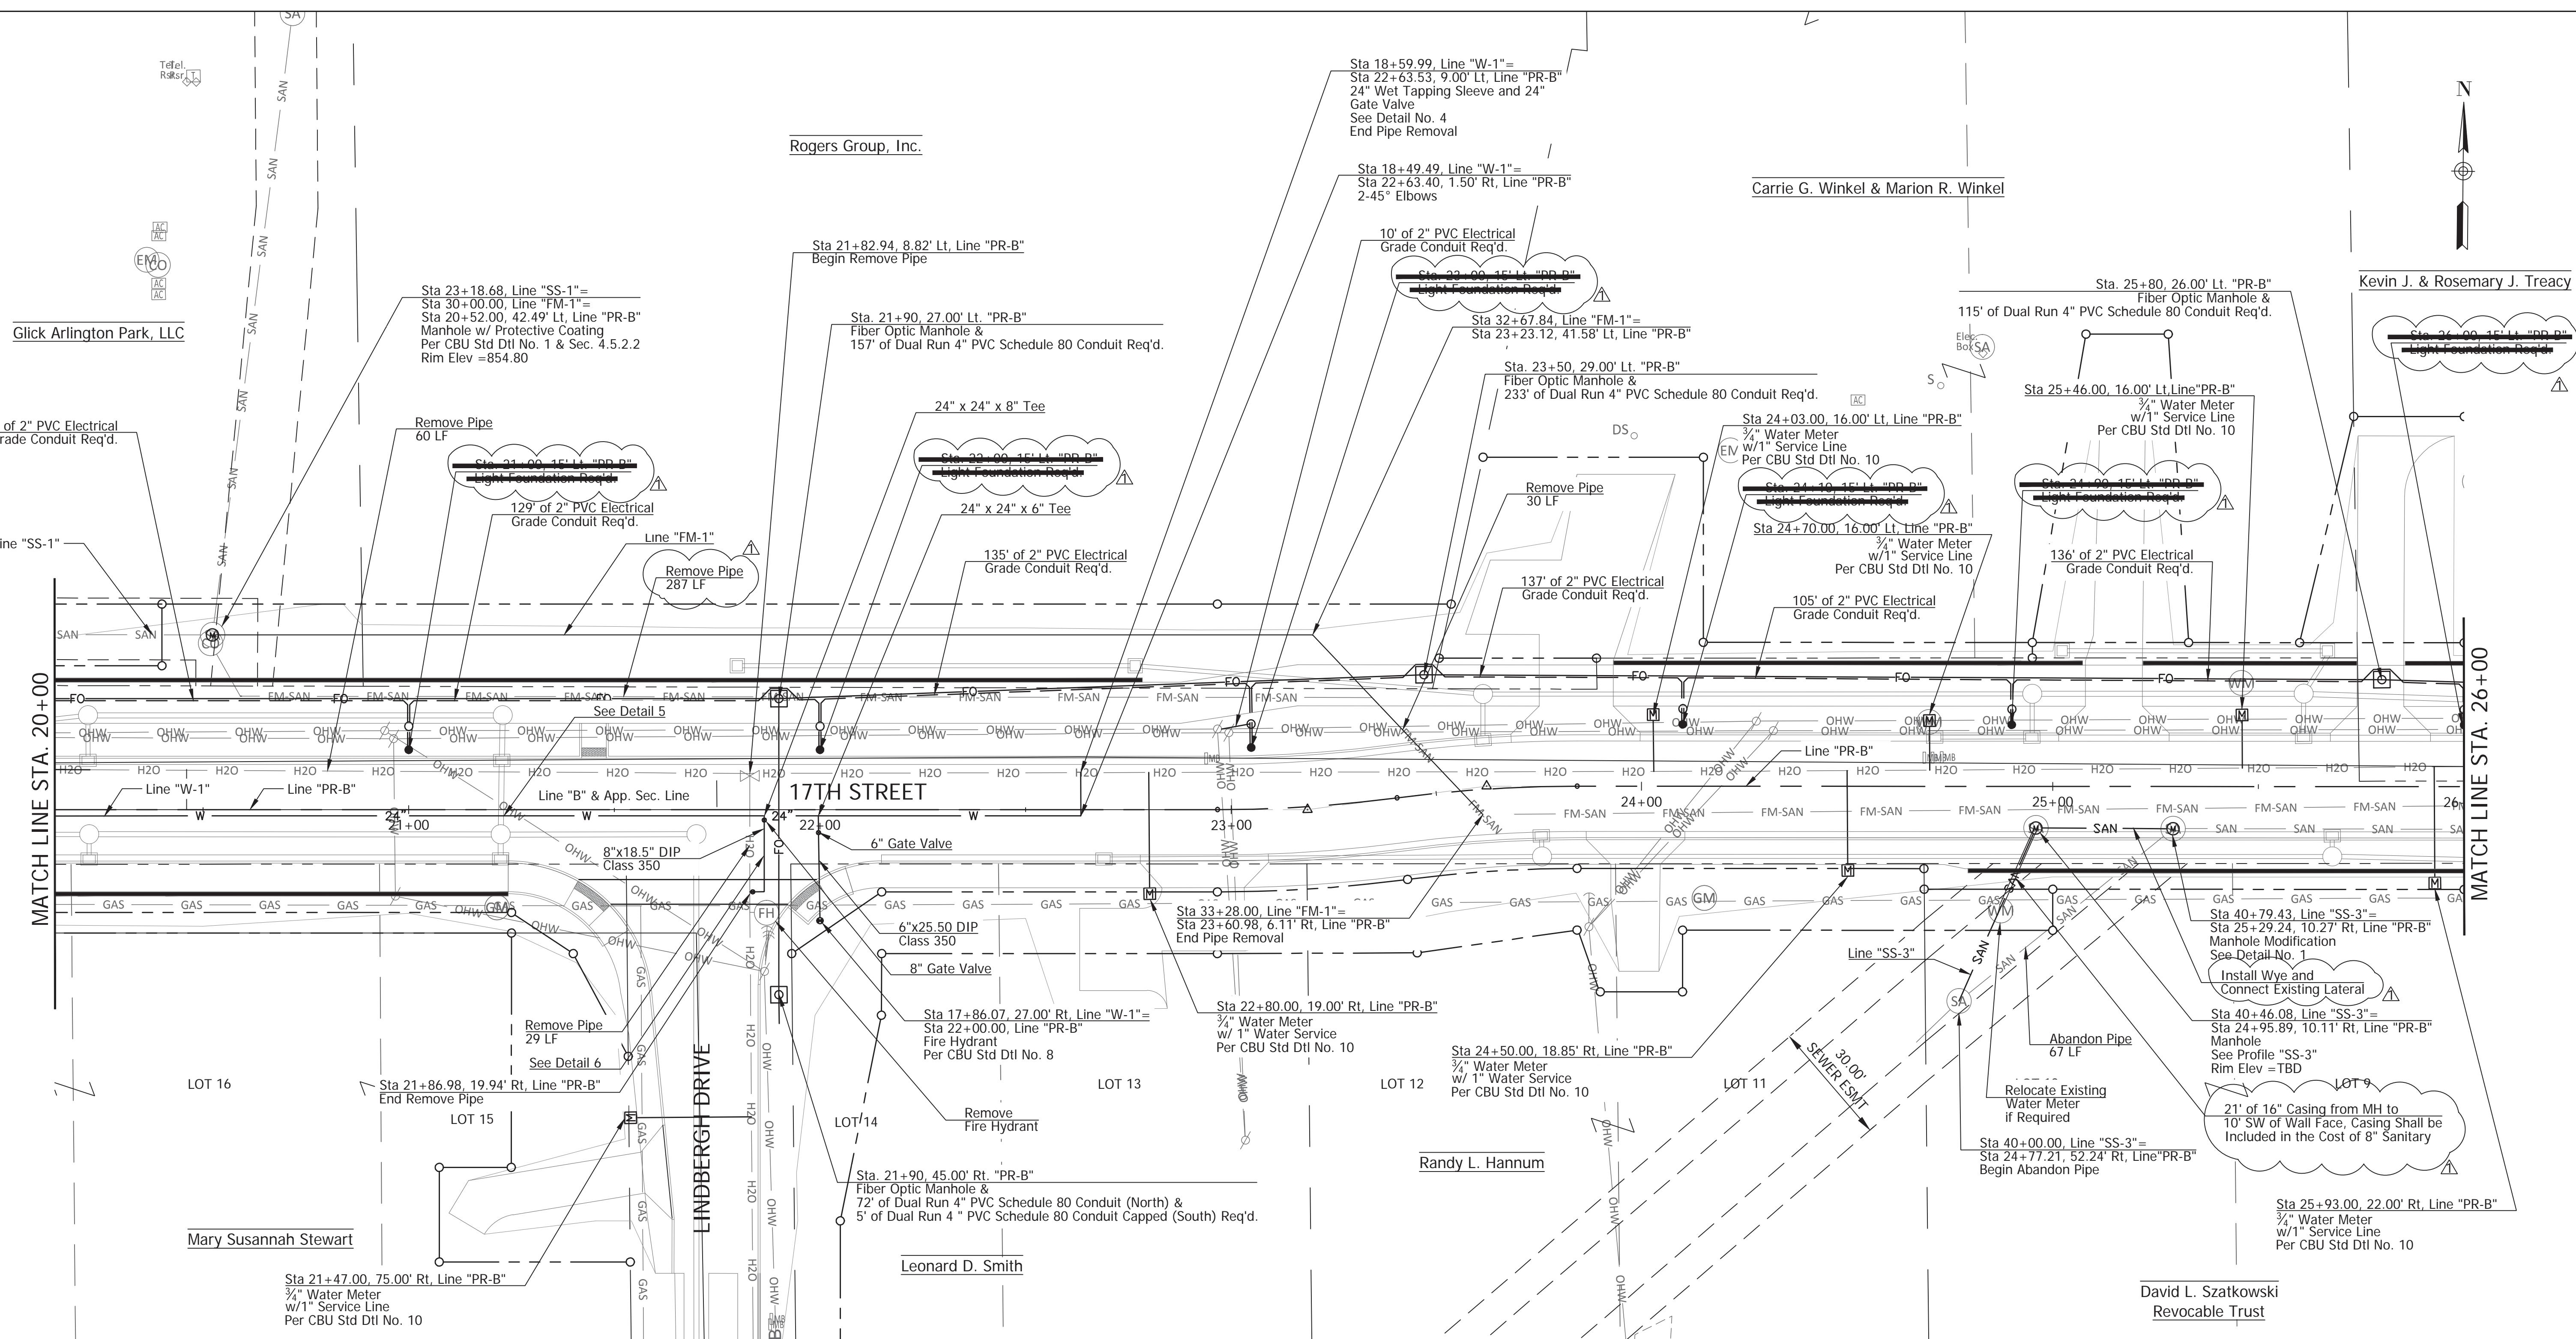

RECOMMENDED FOR APPROVAL

01-23-2019

DESIGN ENGINEER DATE


DESIGNED: LTM DRAWN: CDF

CHECKED: GAG CHECKED: LTM

CITY OF BLOOMINGTON

UTILITY PLAN
STA 20+00 TO STA 26+00

SCALE	BRIDGE FILE
1"=20'	N/A
DESIGNATION	N/A
SURVEY BOOK	Sheets
N/A	48 of 100
CONTRACT	PROJECT
N/A	17TH STREET RECONSTRUCTION

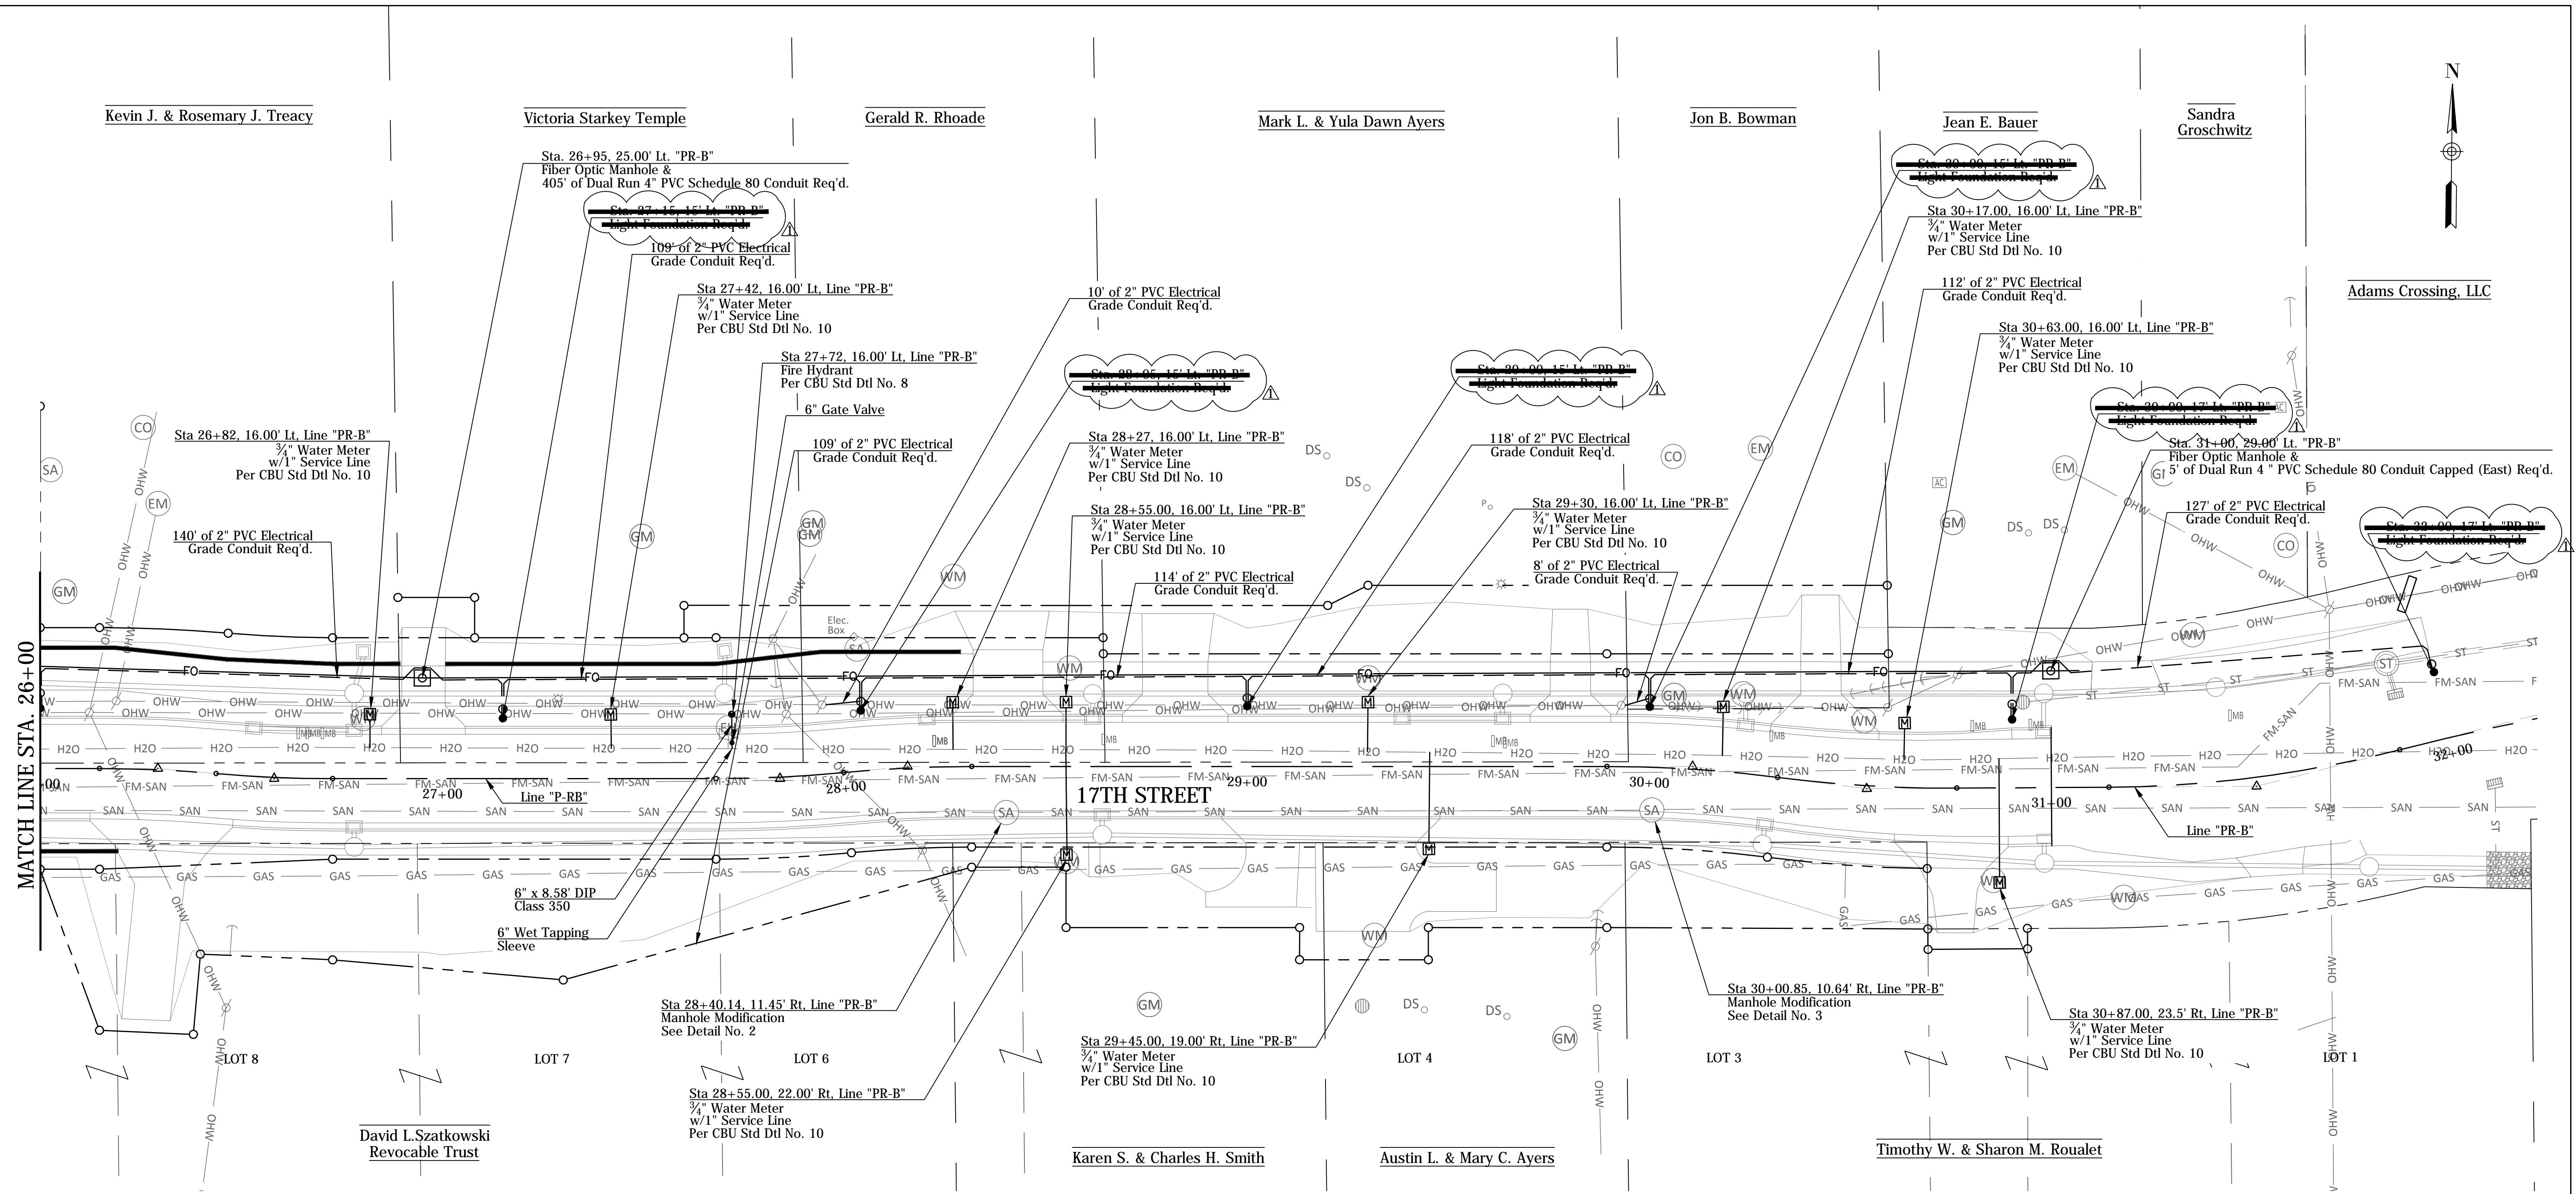

RECOMMENDED FOR APPROVAL

01-23-2019

DESIGN ENGINEER

DATE

DESIGNED: LTM

DRAWN: CDF


CHECKED: GAG

CHECKED: LTM

CITY OF BLOOMINGTON


UTILITY PLAN
STA 26+00 TO STA 32+00

SCALE	BRIDGE FILE
1"=20'	N/A
DESIGNATION	N/A
SURVEY BOOK	SHEETS
N/A	49 of 100
CONTRACT	PROJECT
N/A	17TH STREET RECONSTRUCTION

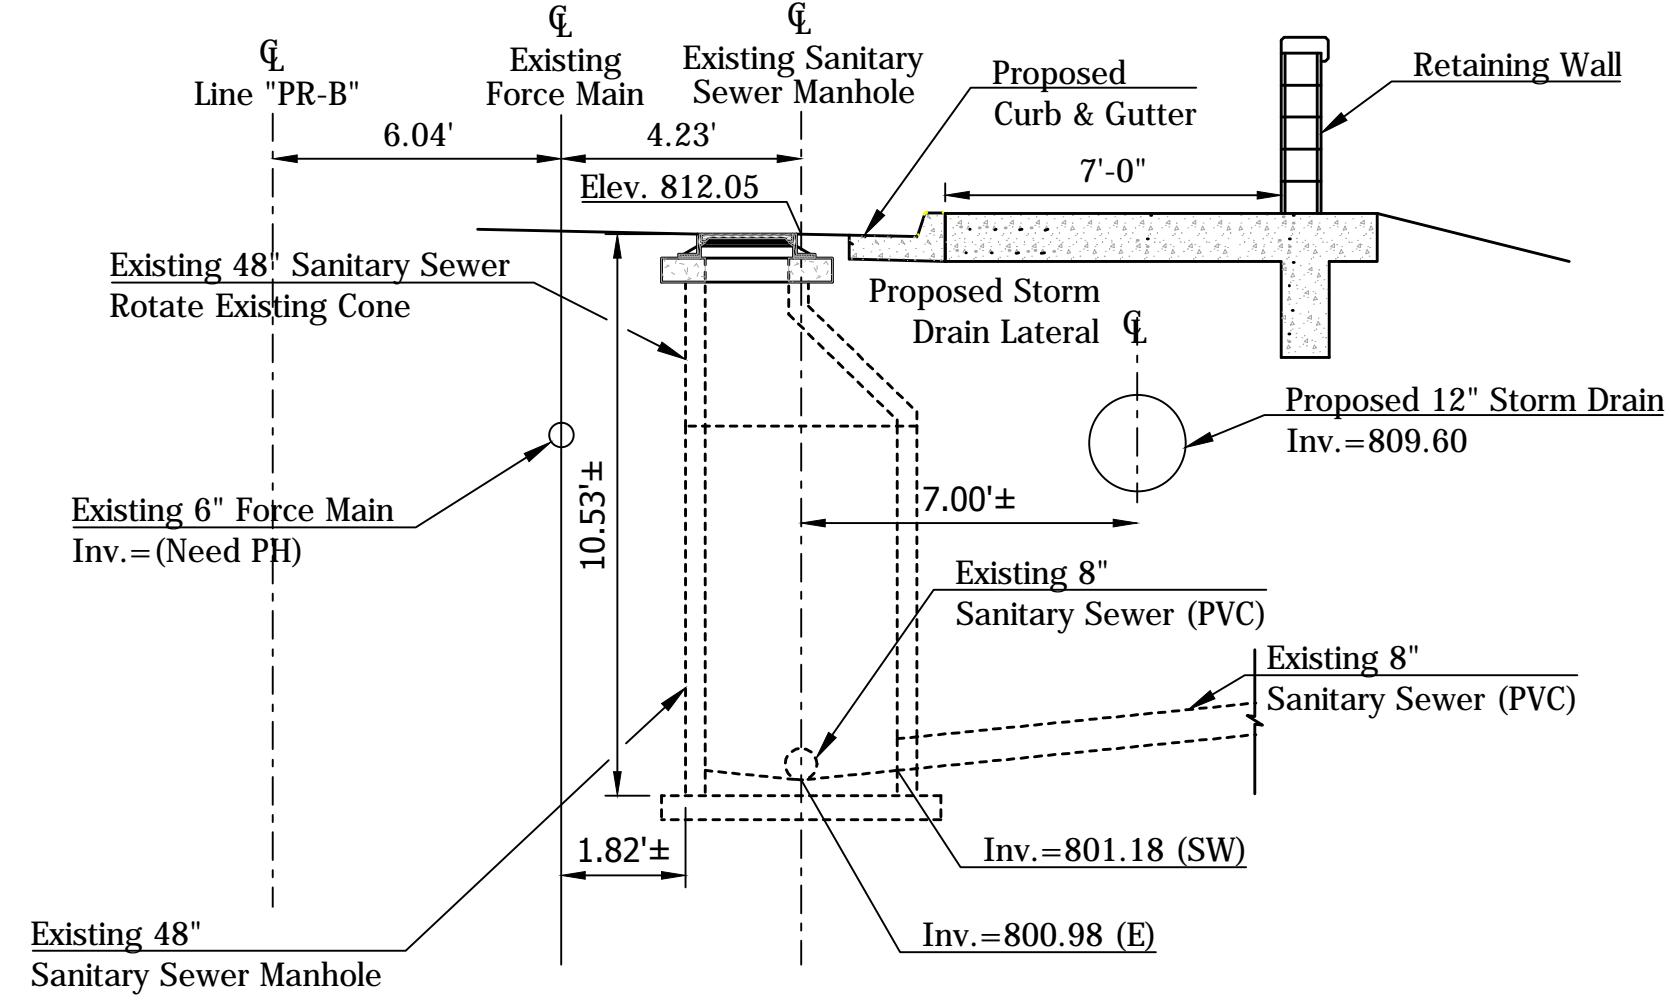


**STATION 25+29.24 LINE "PR-B"
EXISTING SANITARY SEWER
MANHOLE MODIFICATION**

DETAIL 1

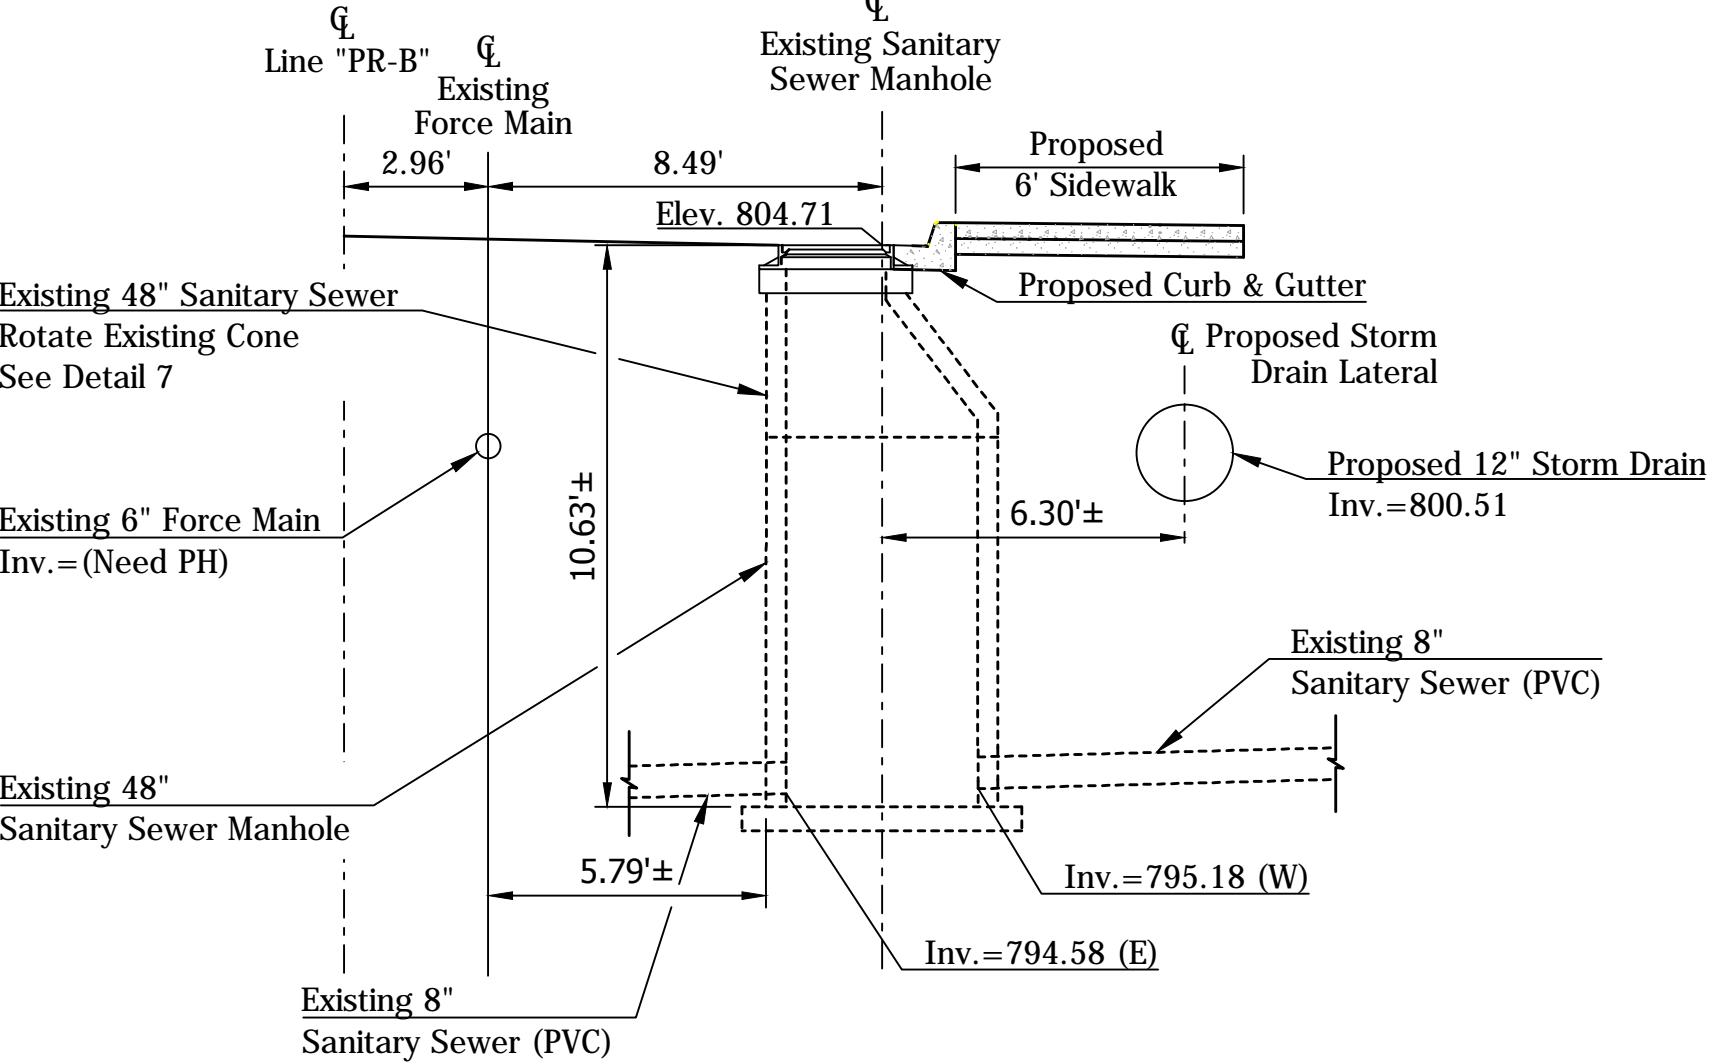


**STATION 28+40.14 LINE "PR-B"
EXISTING SANITARY SEWER
MANHOLE MODIFICATION**

DETAIL 2

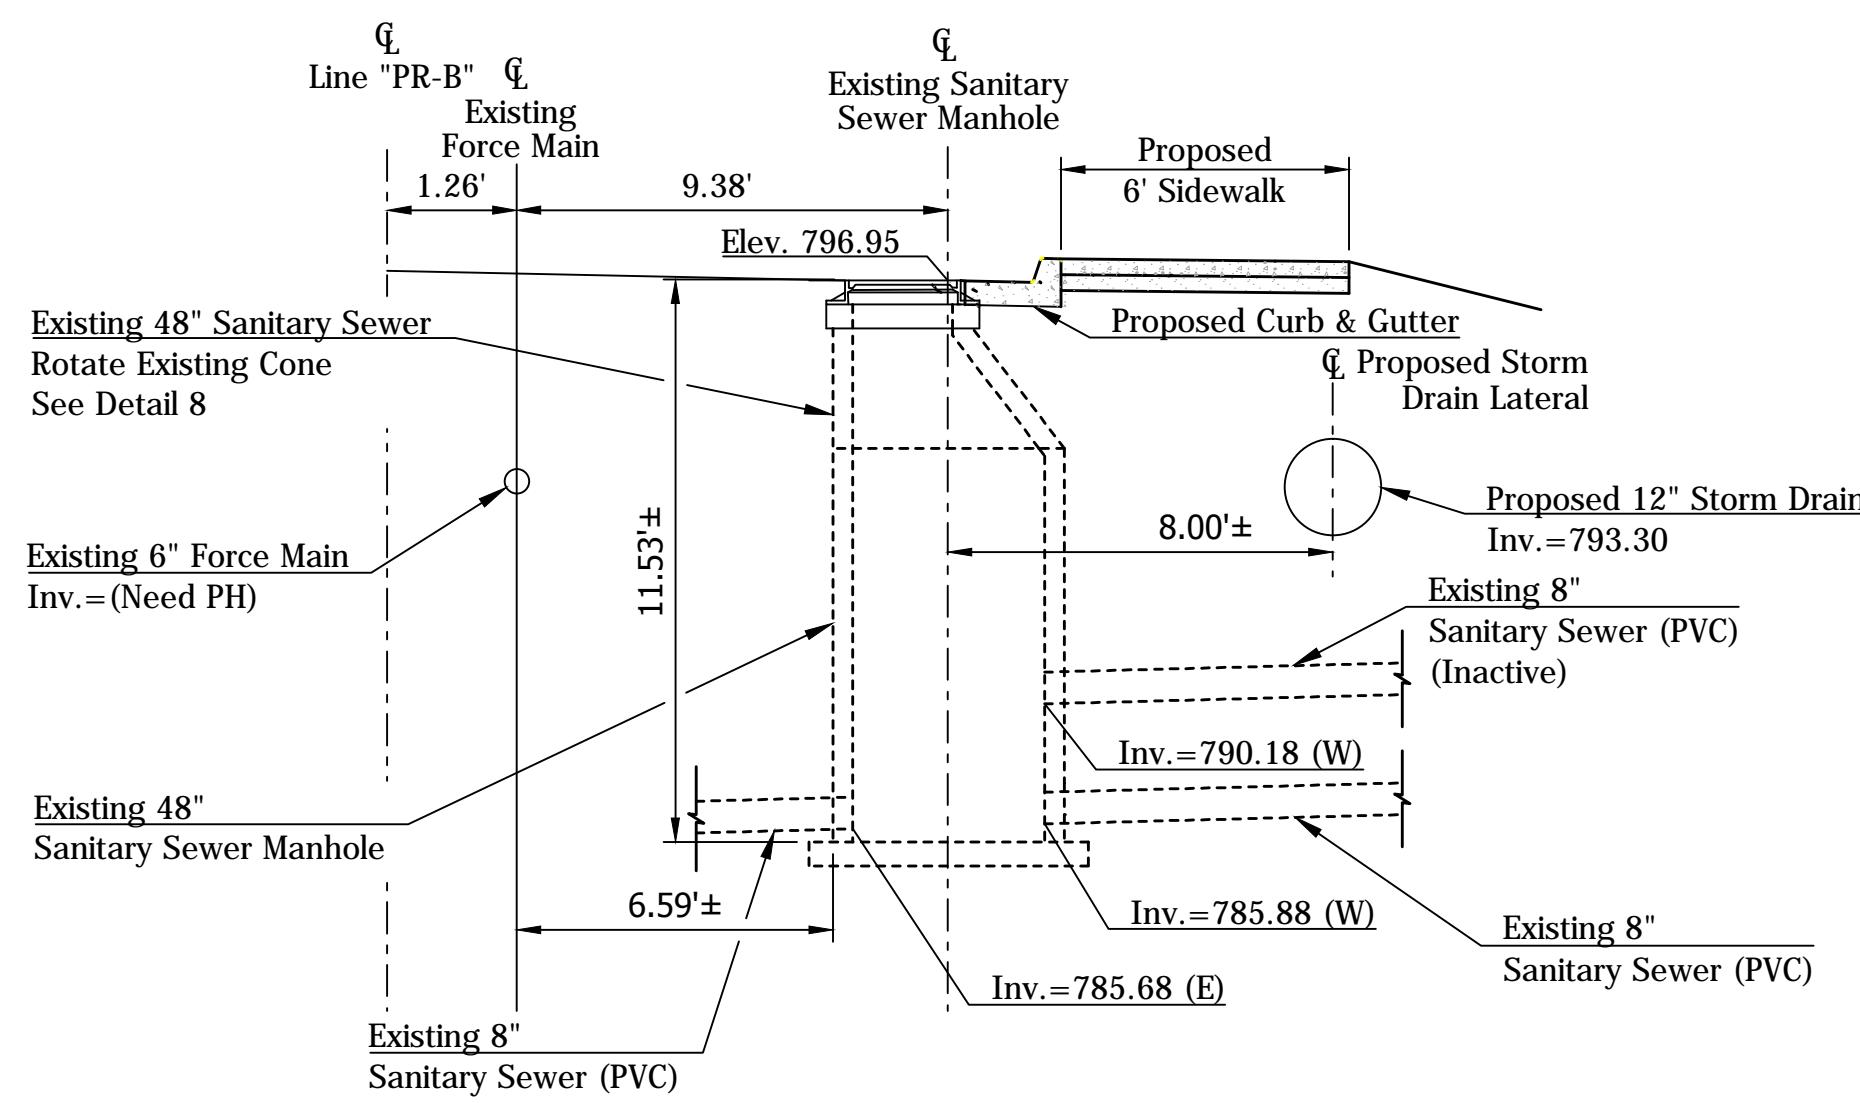

**STATION 30+00.85 LINE "PR-B"
EXISTING SANITARY SEWER
MANHOLE MODIFICATION**


DETAIL 3

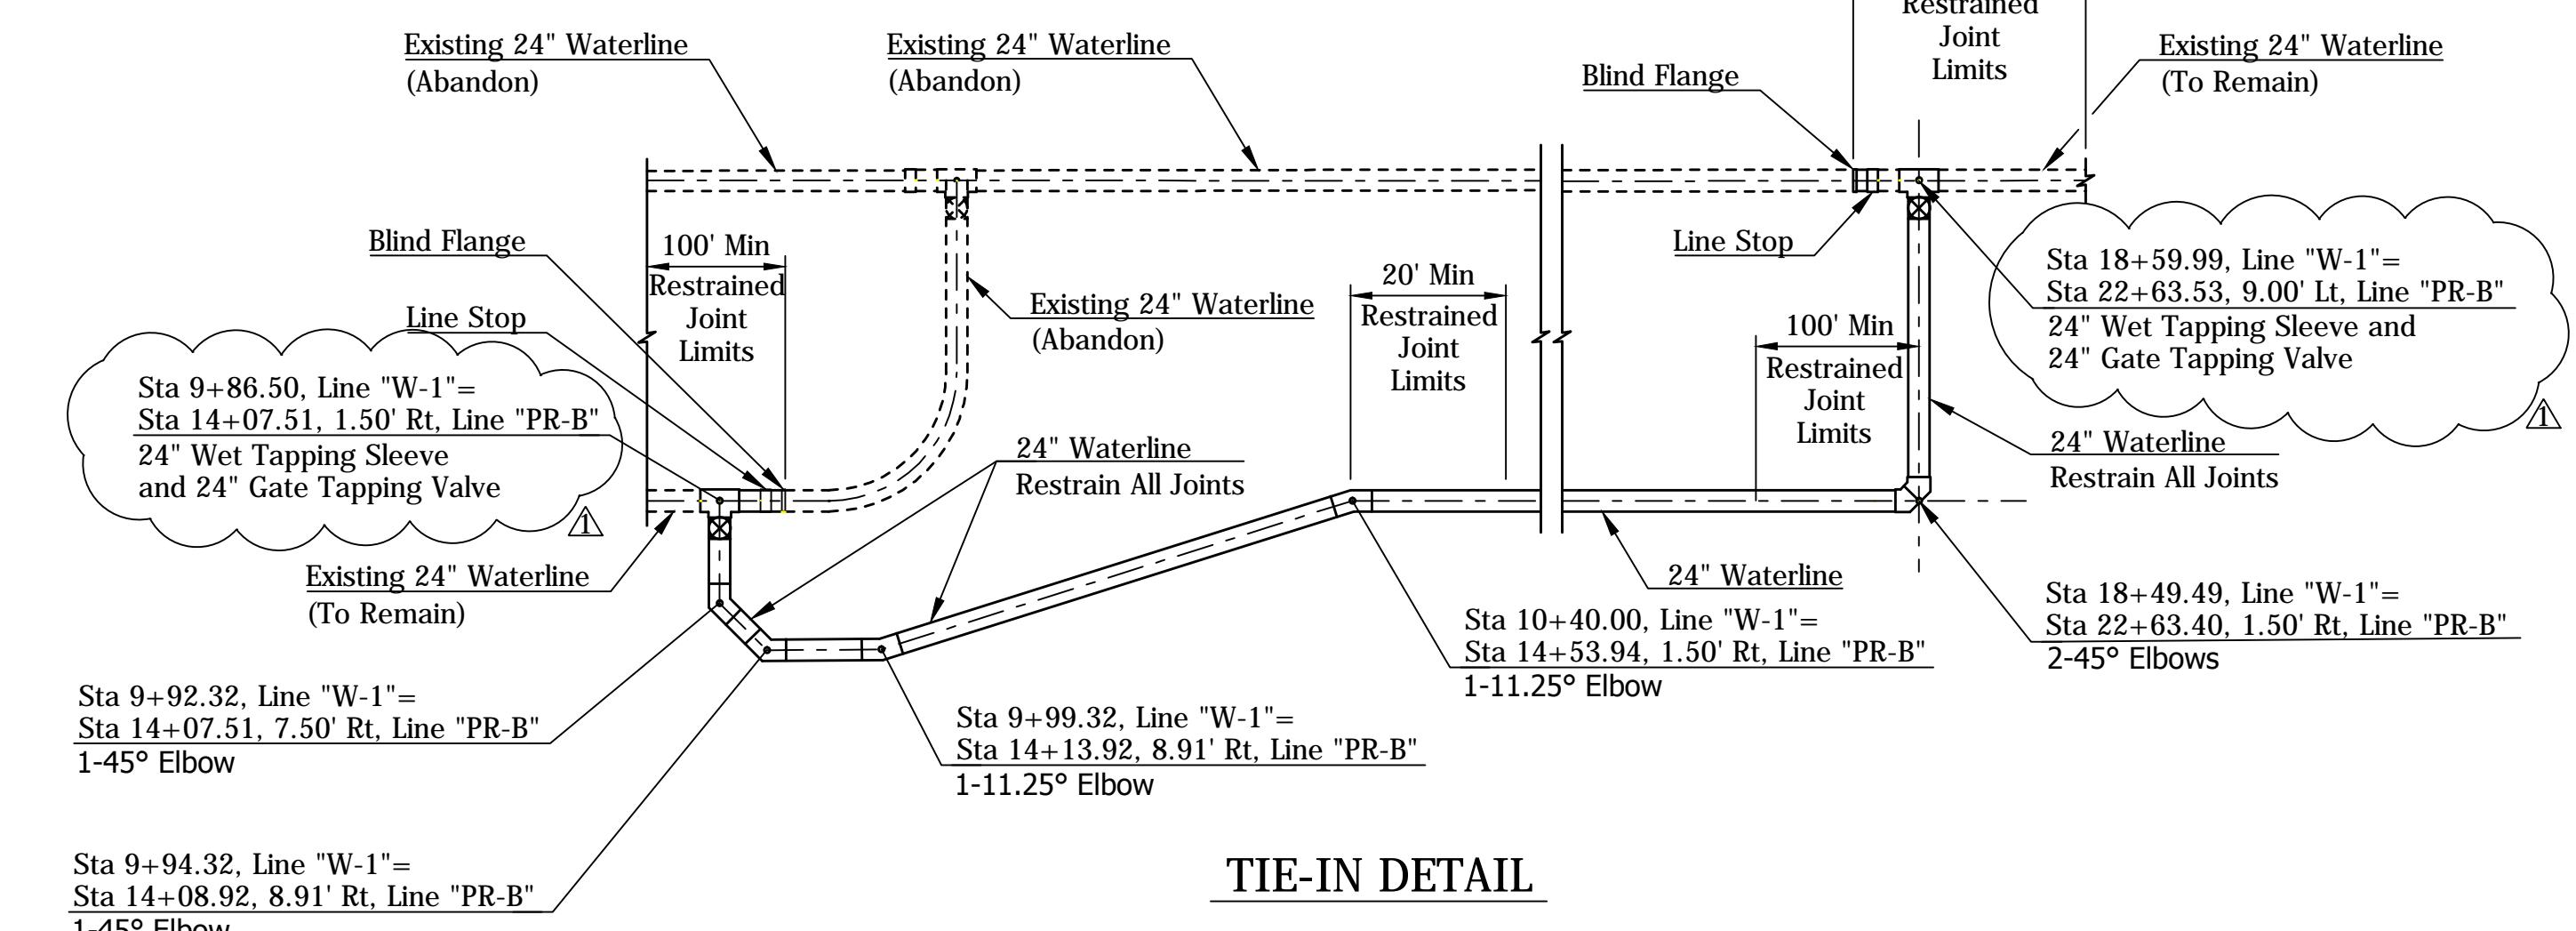

TIE-IN DETAIL

DETAIL 4

*Note: Site Conditions May Require Horizontal Tapping Valves. Contractor to Verify Depth Before Ordering.

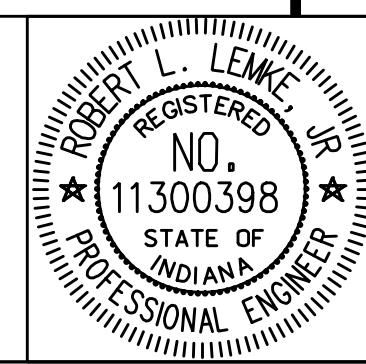



RECOMMENDED FOR APPROVAL *Robert L. Lemke, Jr.* 01-23-2019
DESIGN ENGINEER DATE

DESIGNED: BSF DRAWN: BSF
CHECKED: BSF CHECKED: LAR

CITY OF BLOOMINGTON

UTILITY DETAILS


SCALE	BRIDGE FILE
N.T.S.	N/A
DESIGNATION	
	N/A
SURVEY BOOK	Sheets
N/A	52 of 100
CONTRACT	PROJECT
N/A	17TH STREET RECONSTRUCTION

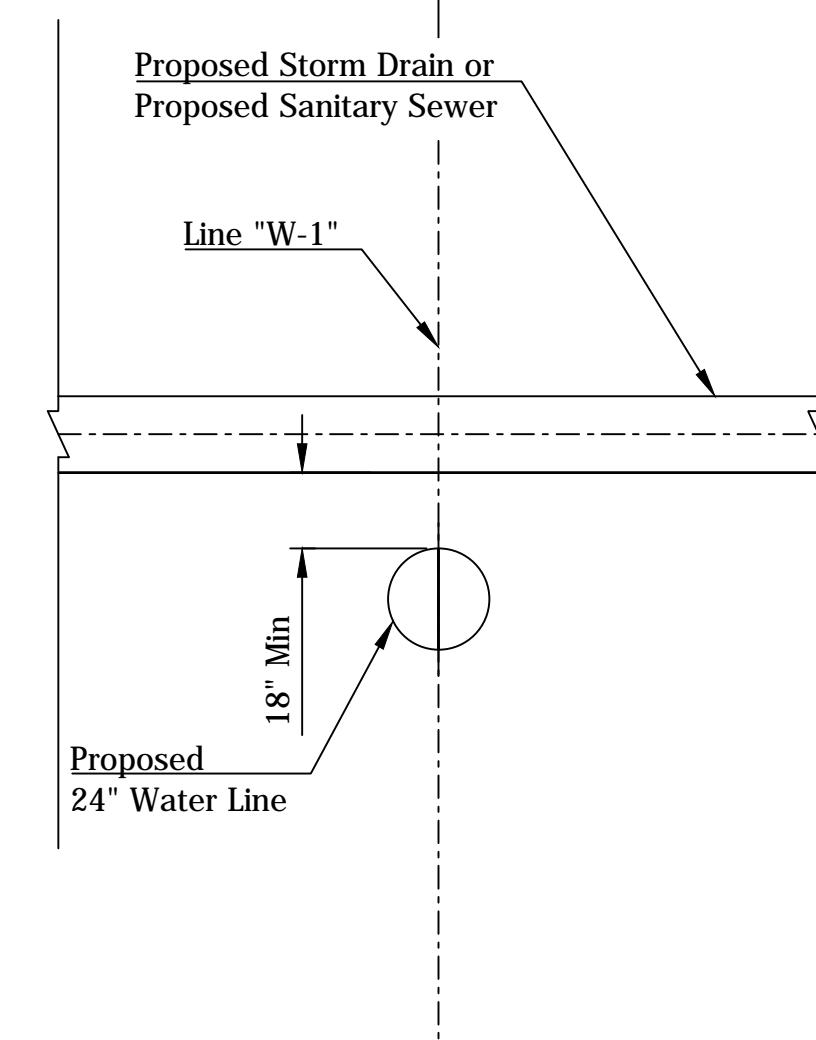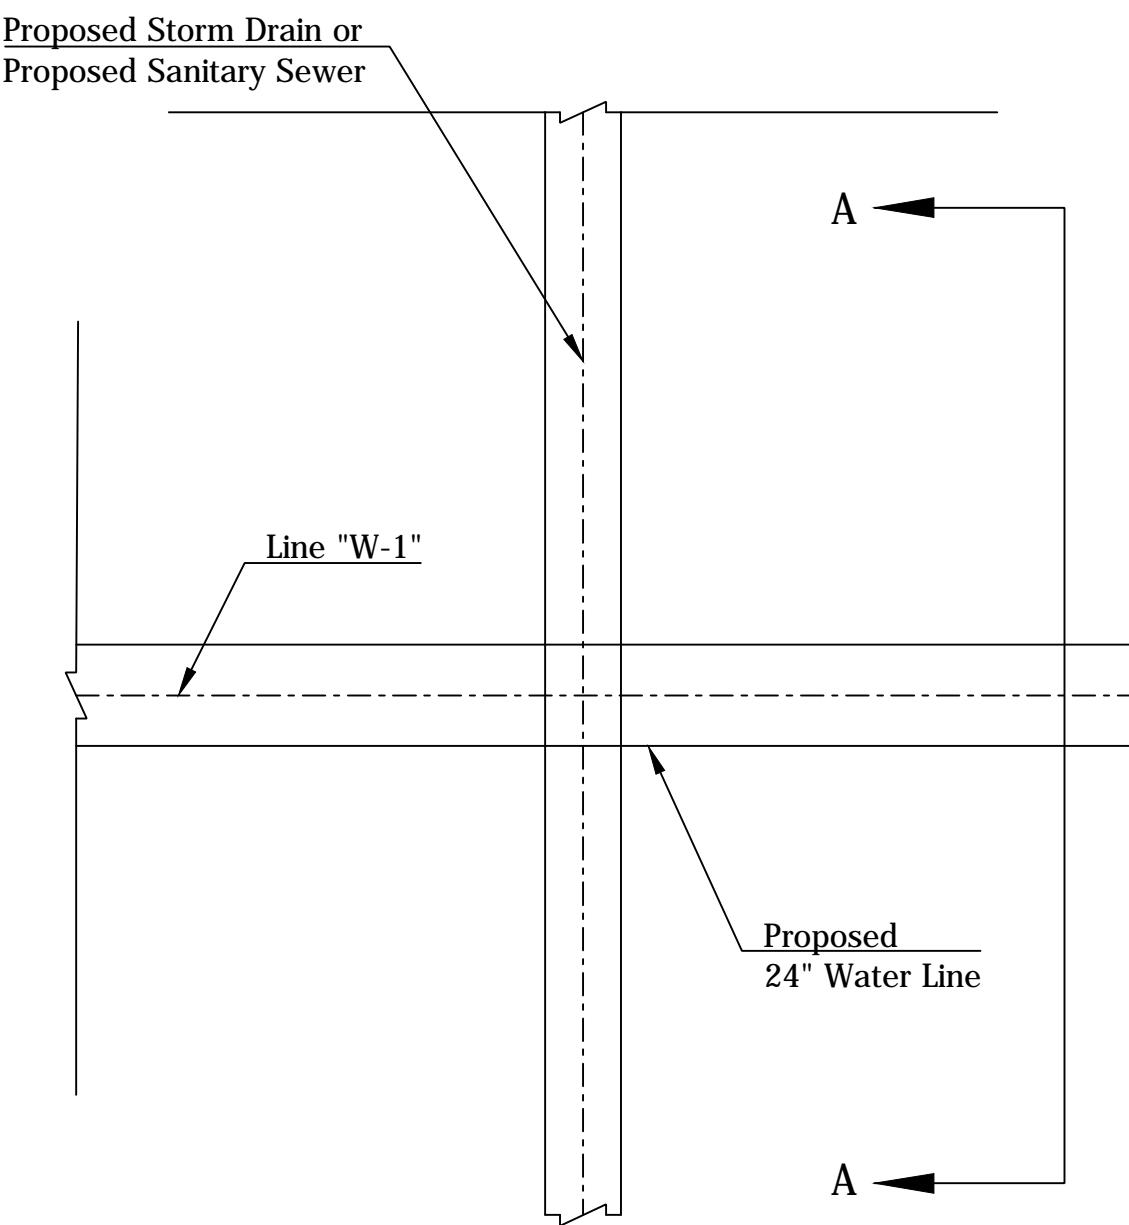

DETAIL 5

STATION 13+00.46 & 17+08.55 LINE "W-1"
STORM SEWER CROSSINGS
STATION 13+83.13 LINE "W-1"
SANITARY SEWER CROSSING


SECTION A-A

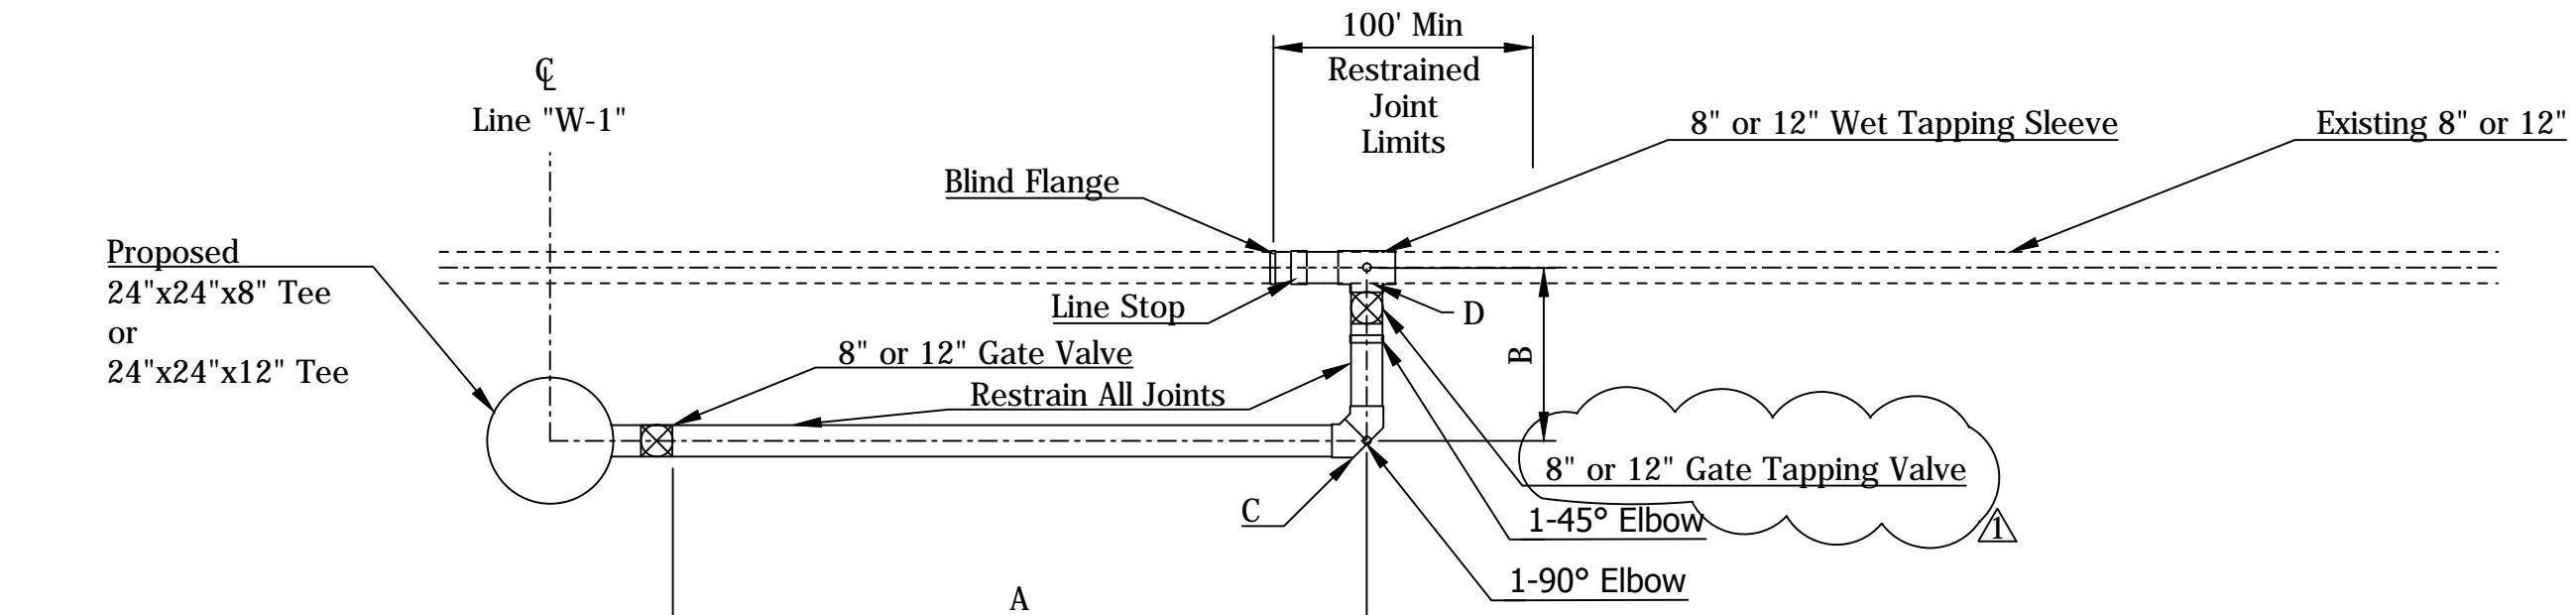

WATERLINE DATA CHART


STATION LINE "W-1"	SIDE	OFFSET (FT)		INVERT	
		A	B	C	D
11+21.96	RIGHT	18.50	2.85	856.01	858.86
13+59.00	LEFT	18.50	3.47	848.01	851.48
17+69.04	RIGHT	18.50	4.58	829.27	833.85

DETAIL 6

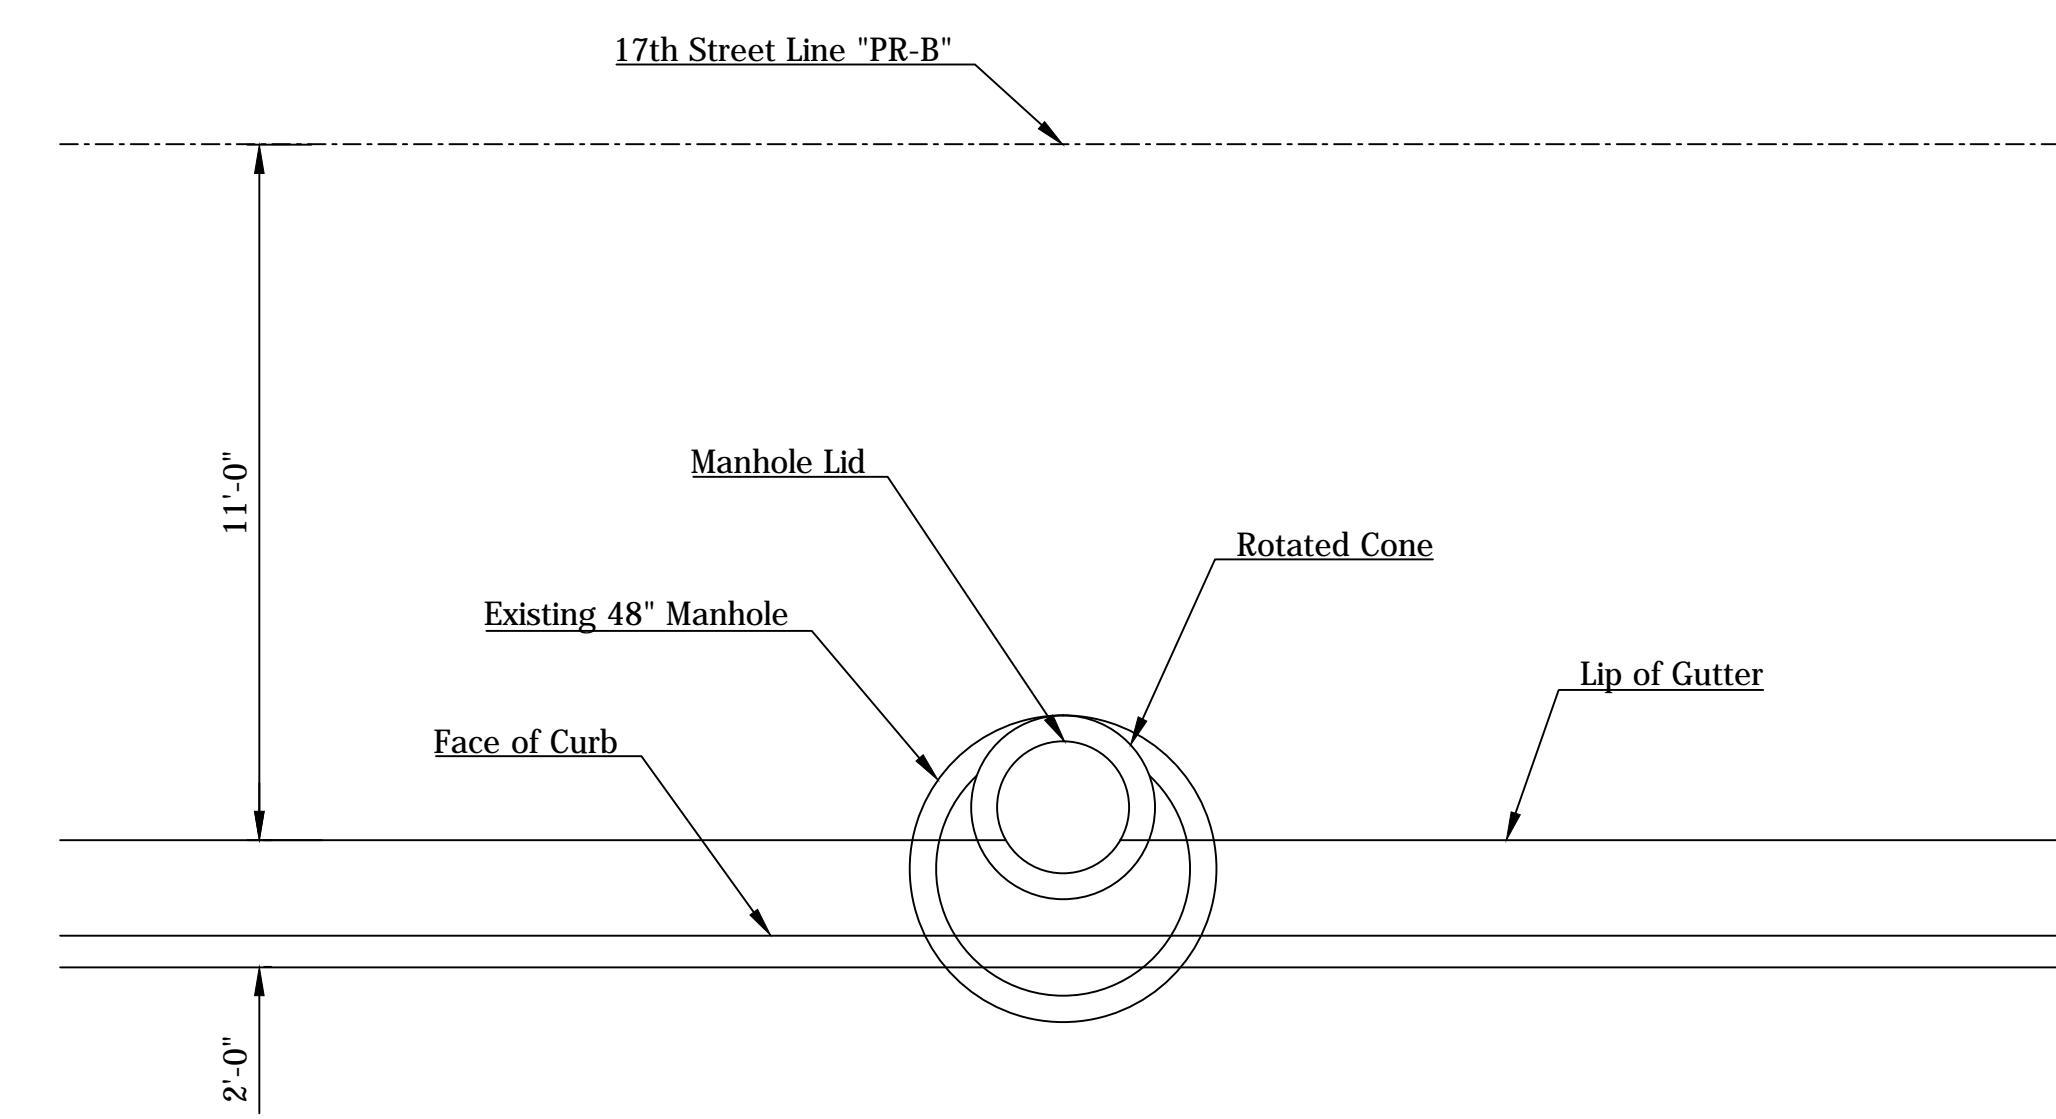


MANHOLE AT STATION 28+40.14 LINE "PR-B"

DETAIL 7

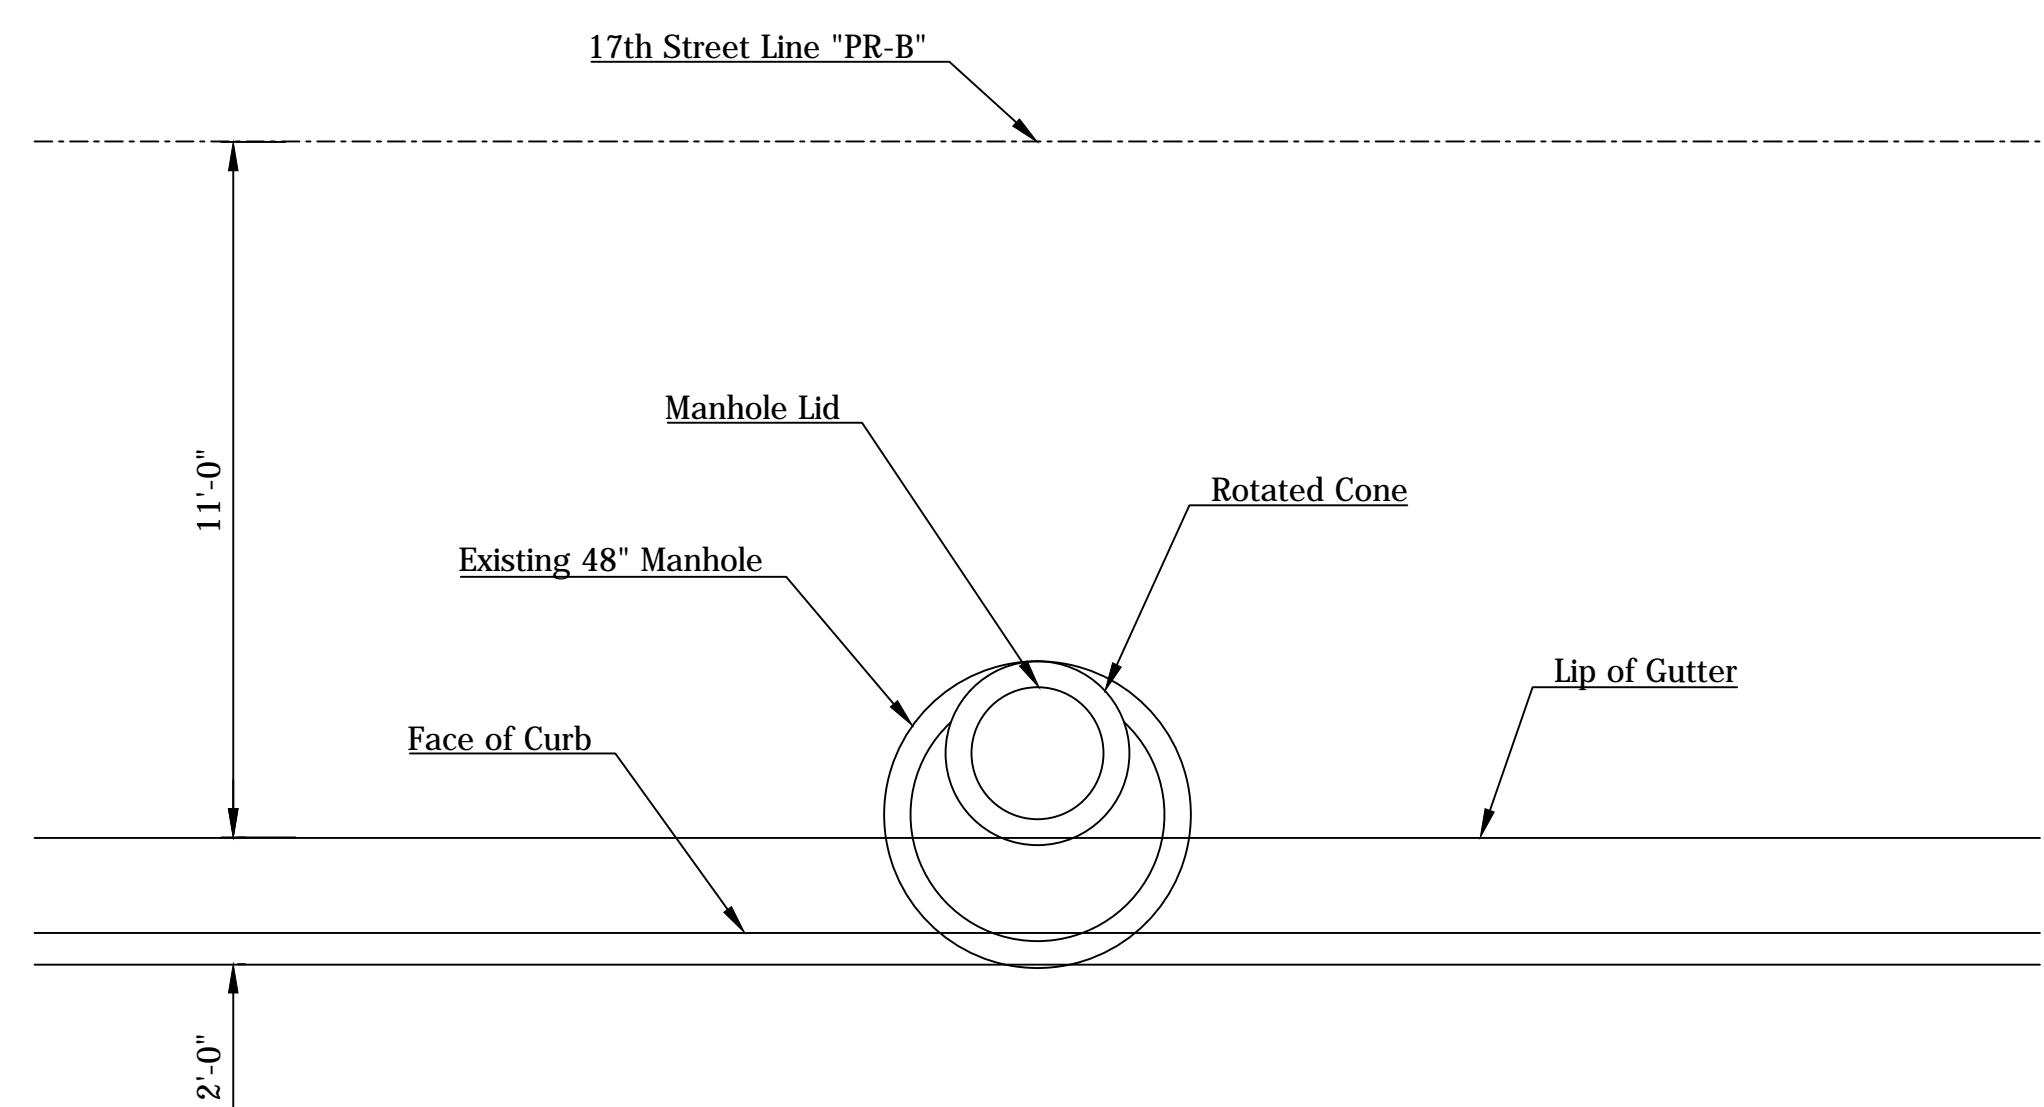

MANHOLE AT STATION 30+00.85 LINE "PR-B"

DETAIL 8

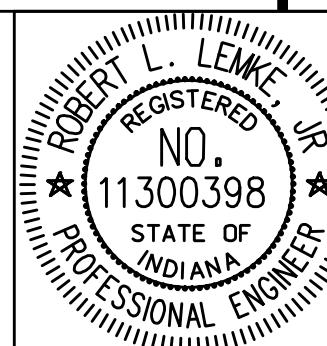


RECOMMENDED FOR APPROVAL	<i>Robert L. Lemke, Jr.</i>	01-23-2019
DESIGNED:	LTM	DRAWN: CDF
CHECKED:	GAG	CHECKED: LTM

CITY OF BLOOMINGTON

UTILITY DETAILS



SCALE	BRIDGE FILE
N.T.S.	N/A
DESIGNATION	
N/A	
SURVEY BOOK	SHEETS
N/A	53 of 100
CONTRACT	PROJECT
N/A	17TH STREET RECONSTRUCTION

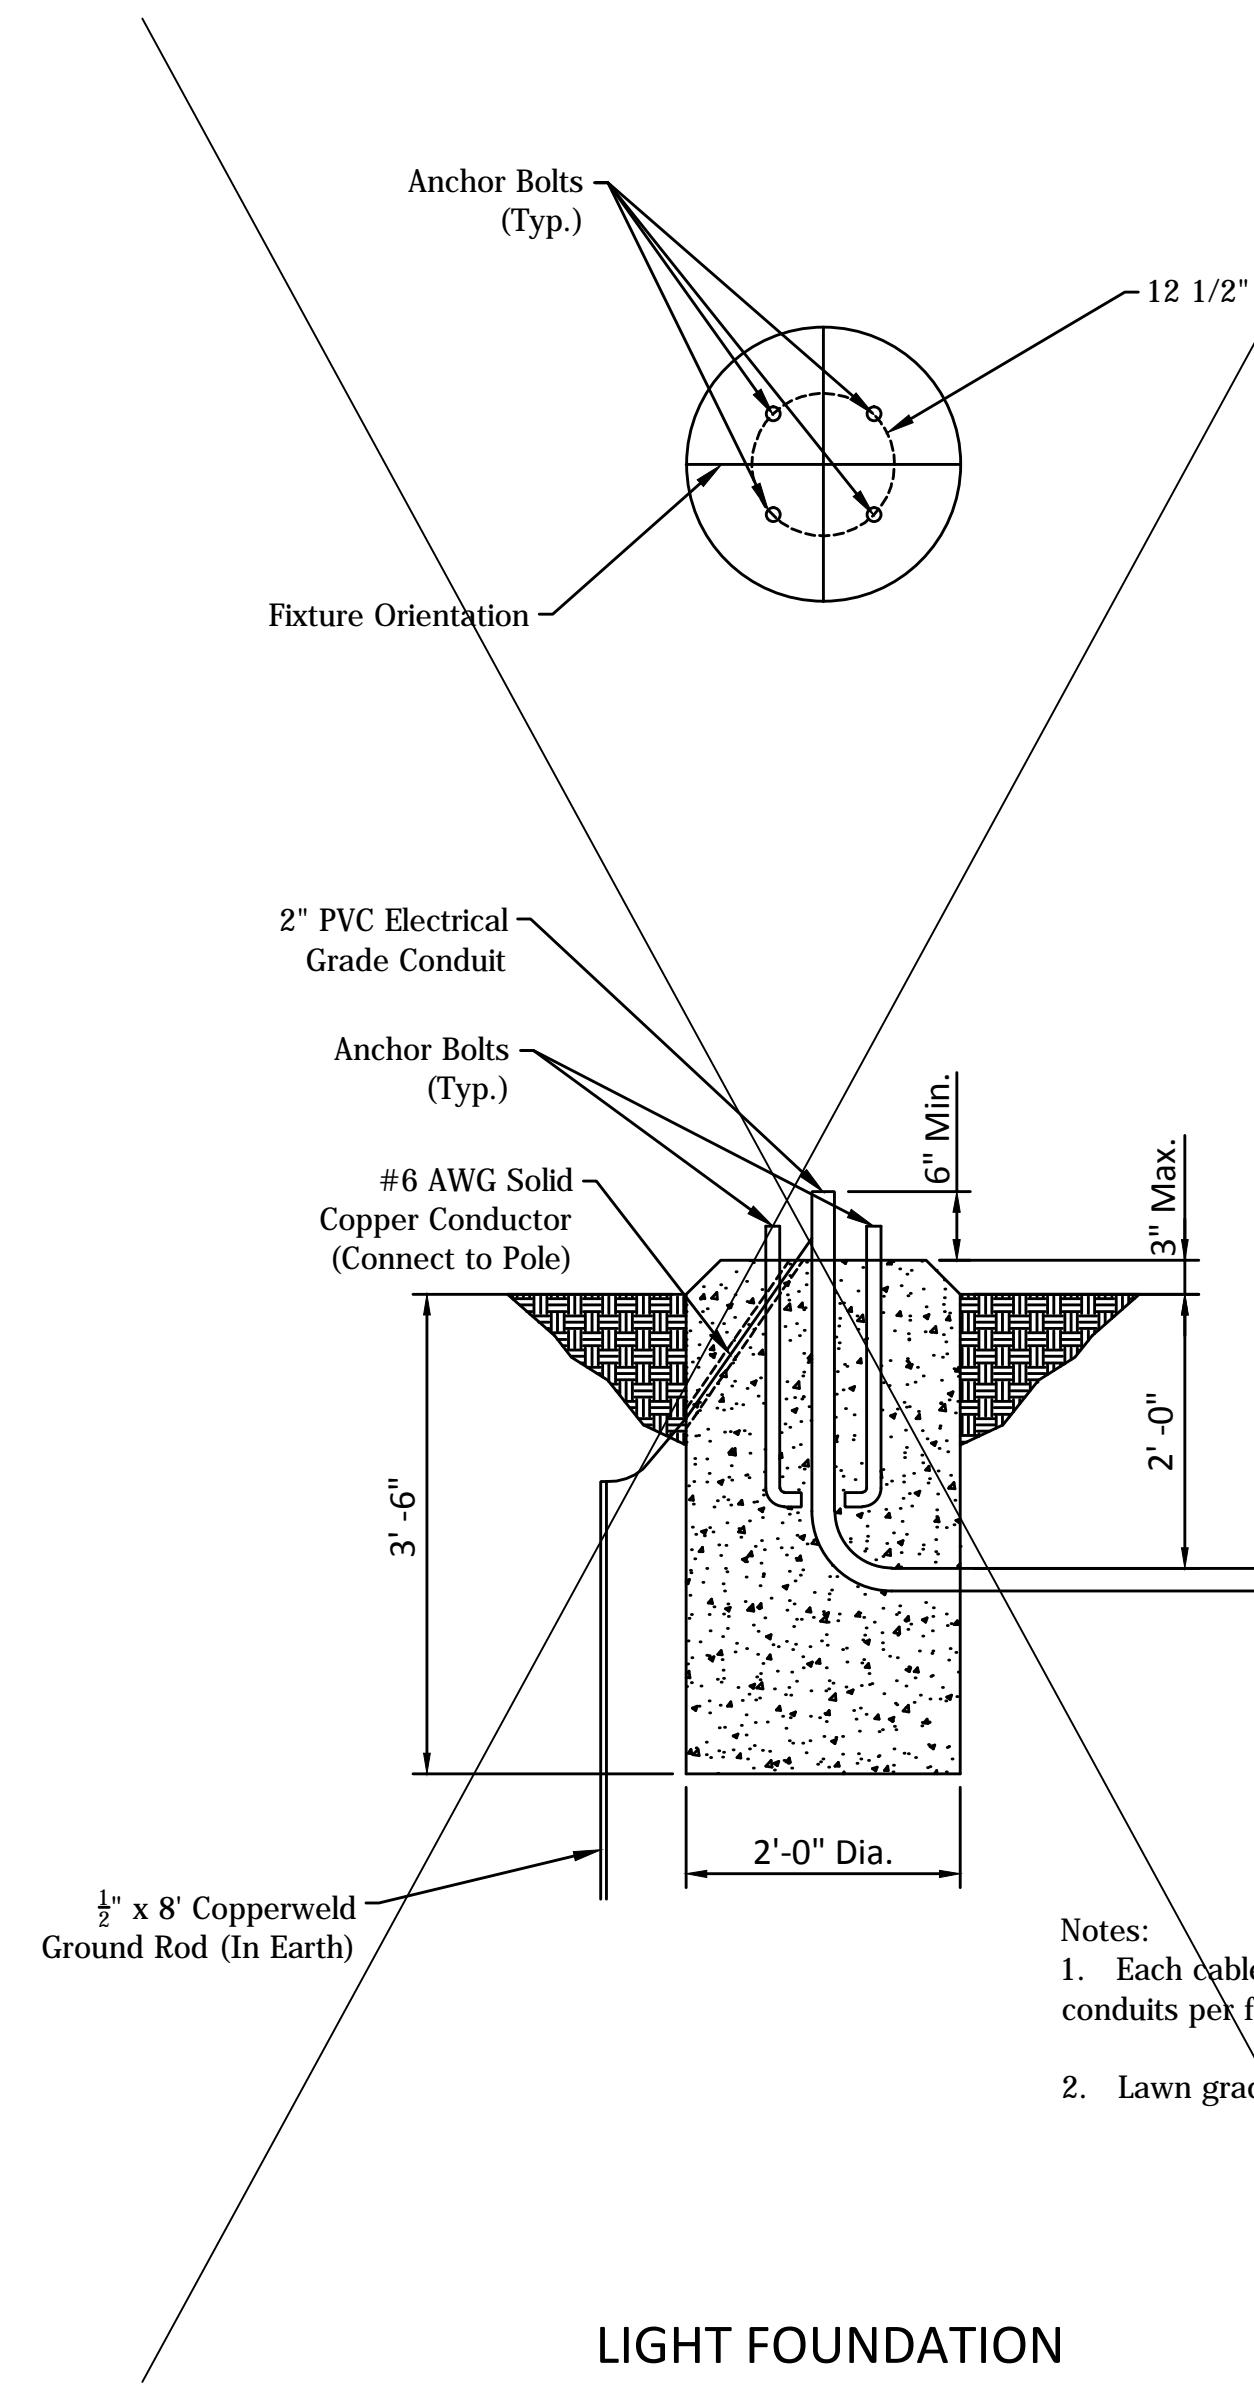


Notes:
 1. Each cable shall have its own conduit. There shall be at least two conduits per foundation.
 2. Lawn grading shall be flush as shown.

LIGHT FOUNDATION

Duke Energy will be providing and installing direct buried light poles.

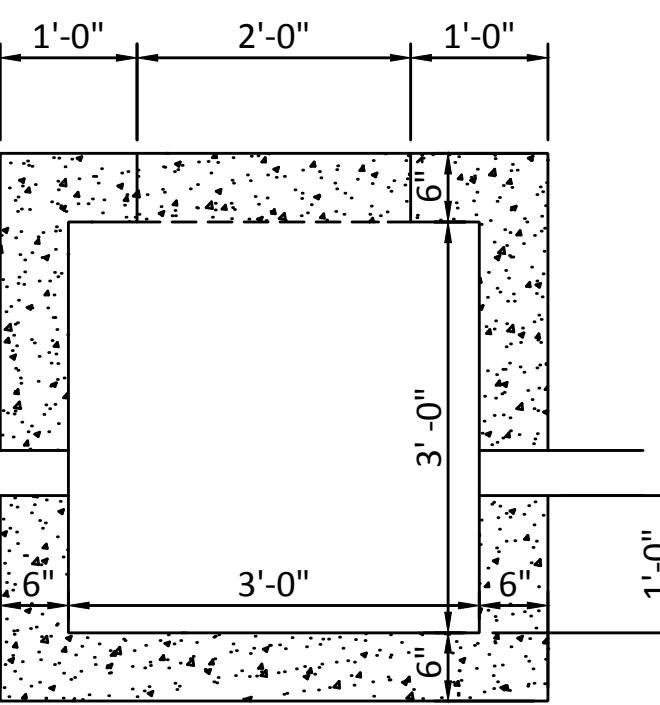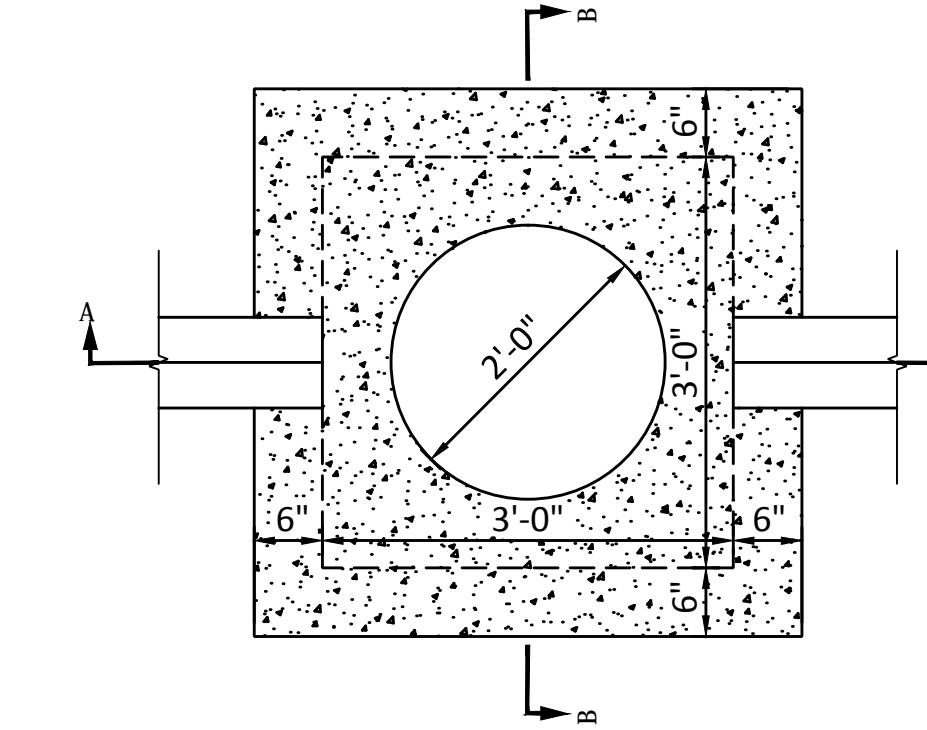

SECTION A-A

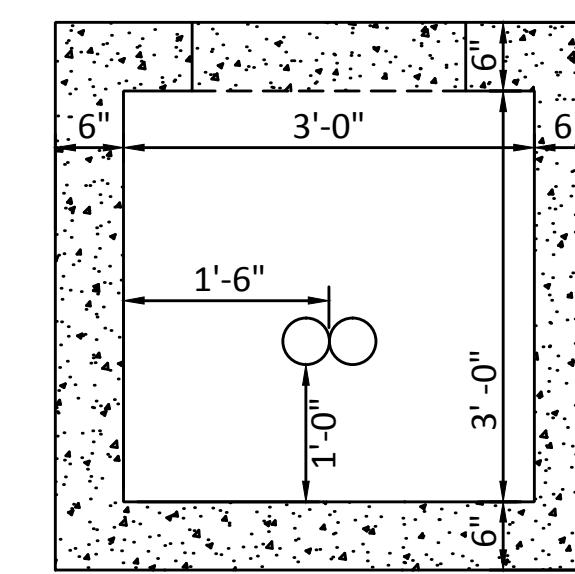

SECTION B-B

FIBER OPTIC MANHOLE



RECOMMENDED
FOR APPROVAL

Robert L. Lemke, Jr.

01-23-2019

DESIGN ENGINEER

DATE

DESIGNED: BSF DRAWN: BSF

CHECKED: LAR CHECKED: PRD



CITY OF BLOOMINGTON

MISCELLANEOUS UTILITY
STRUCTURE DETAILS

SCALE	BRIDGE FILE
N/A	
DESIGNATION	N/A
N/A	
SURVEY BOOK	SHEETS
N/A	54 of 100
CONTRACT	PROJECT
N/A	17TH STREET RECONSTRUCTION

LEGEND SYMBOL	BOTANICAL NAME	COMMON NAME	SIZE	QTY THIS SHEET
ACER RUBRUM		RED MAPLE	2" B&B	0 EA
CERCIS CANADENSIS		EASTERN REDBUD	1-1/4" B&B	0 EA
MALUS 'RED BARRON'		RED BARRON CRABAPPLE	1-1/4" B&B	5 EA
CRATAEGUS PHAENOPYRAM		WASHINGTON HAWTHORN	2" B&B	8 EA
JUNIPERUS VIRGINIANA		EASTERN RED CEDAR	1-1/4" B&B	0 EA
PINUS STROBUS		EASTERN WHITE PINE	2" B&B	0 EA
QUERCUS PALUSTRIS		PIN OAK	2" B&B	0 EA
THUJA OCCIDENTALIS 'SMARAGD'		EMERALD GREEN ARBORVITAE	2" B&B	0 EA
	SODDING, NURSERY			684 SY


LEGEND SYMBOLS ARE NOT TO SCALE

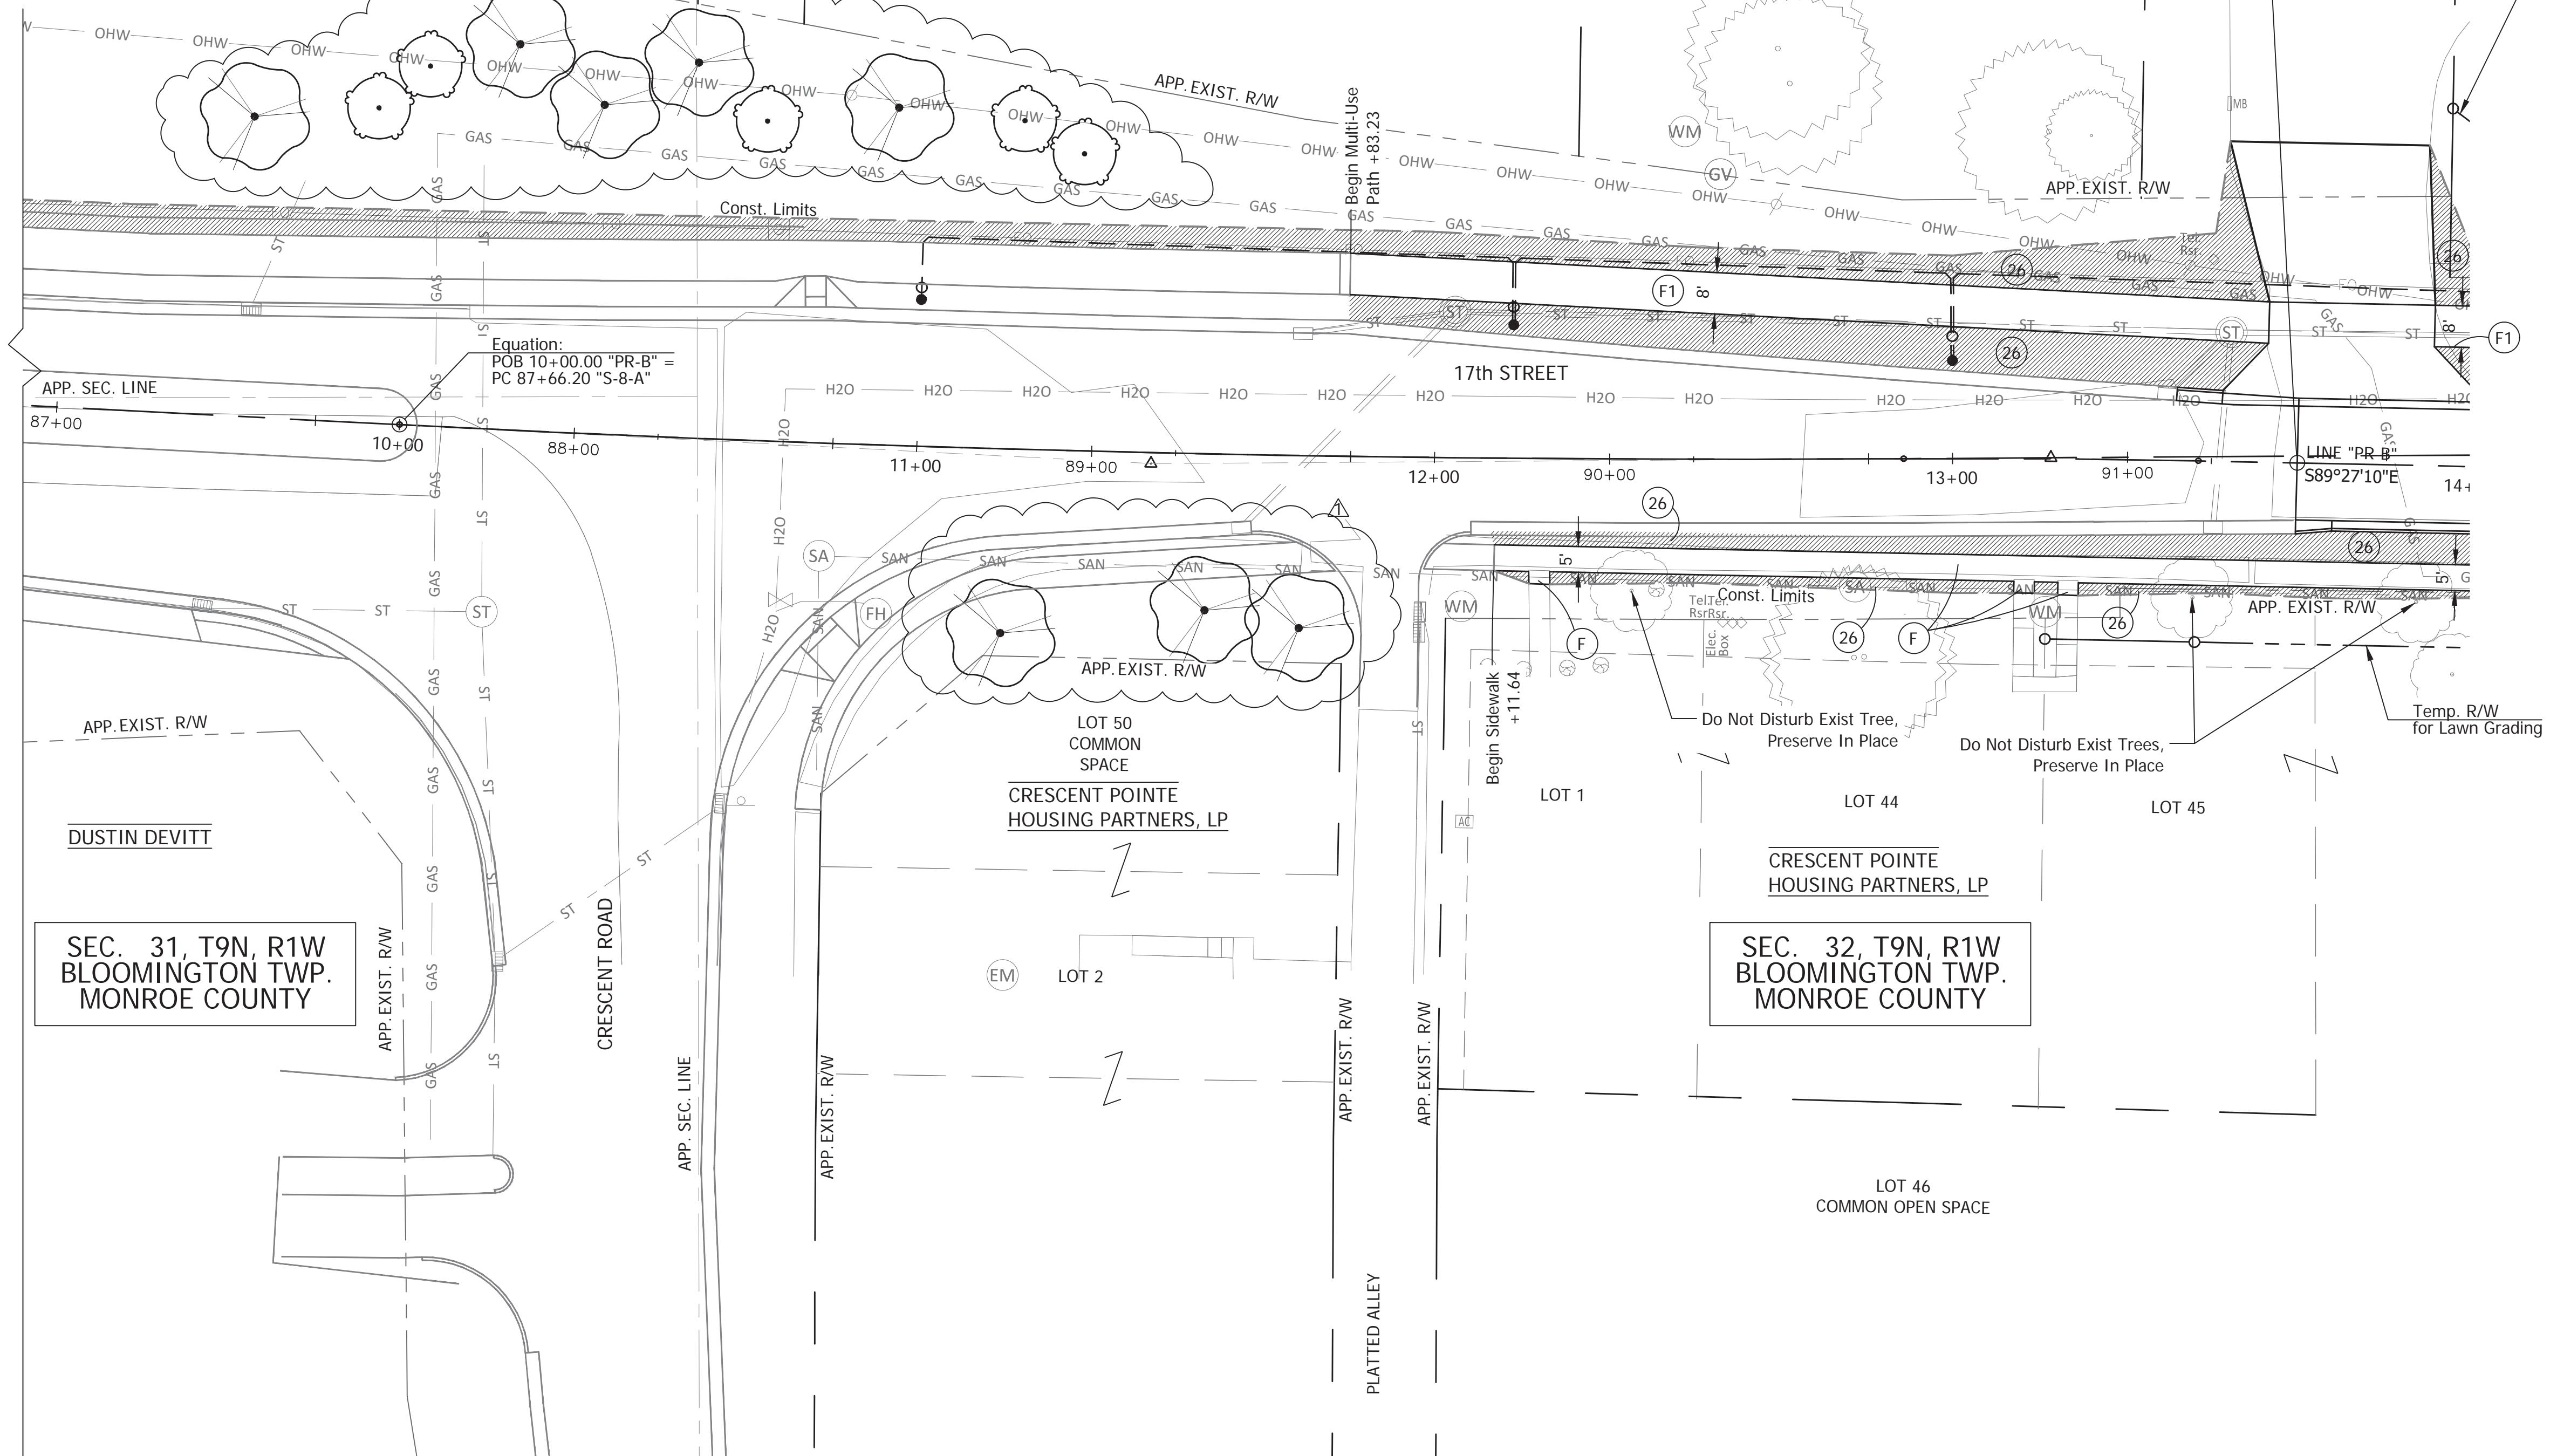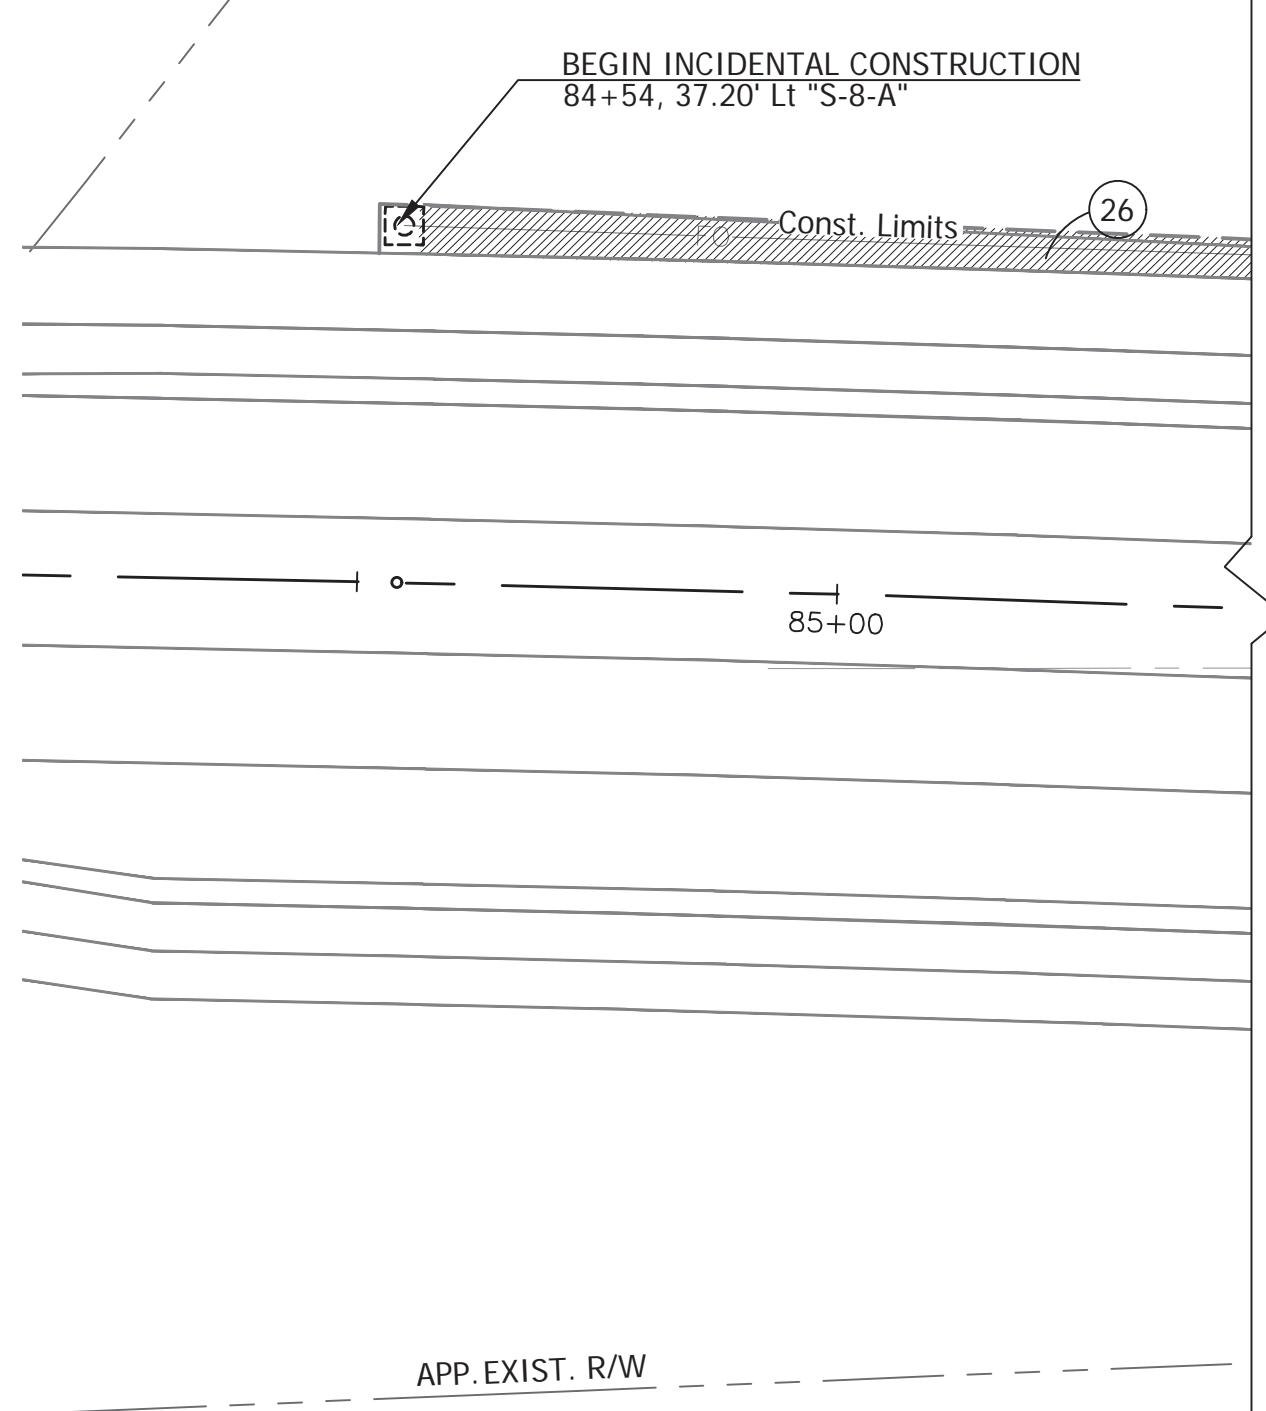


LEGEND SYMBOL	BOTANICAL NAME	COMMON NAME	SIZE	QTY THIS SHEET
	ACER RUBRUM	RED MAPLE	2" B&B	0 EA
	CERCIS CANADENSIS	EASTERN REDBUD	1-1/4" B&B	0 EA
	MALUS 'RED BARRON'	RED BARRON CRABAPPLE	1-1/4" B&B	0 EA
	CRATAEGUS PHAENOPYRAM	WASHINGTON HAWTHORN	2" B&B	0 EA
	JUNIPERUS VIRGINIANA	EASTERN RED CEDAR	1-1/4" B&B	0 EA
	PINUS STROBOS	EASTERN WHITE PINE	2" B&B	0 EA
	QUERCUS PALUSTRIS	PIN OAK	2" B&B	0 EA
	THUJA OCCIDENTALIS 'SMARAGD'	EMERALD GREEN ARBORVITAE	2" B&B	0 EA
	SODDING, NURSERY			17 SY

LEGEND SYMBOLS ARE NOT TO SCALE

SEC. 29, T9N, R1W
BLOOMINGTON TWP.
MONROE COUNTY

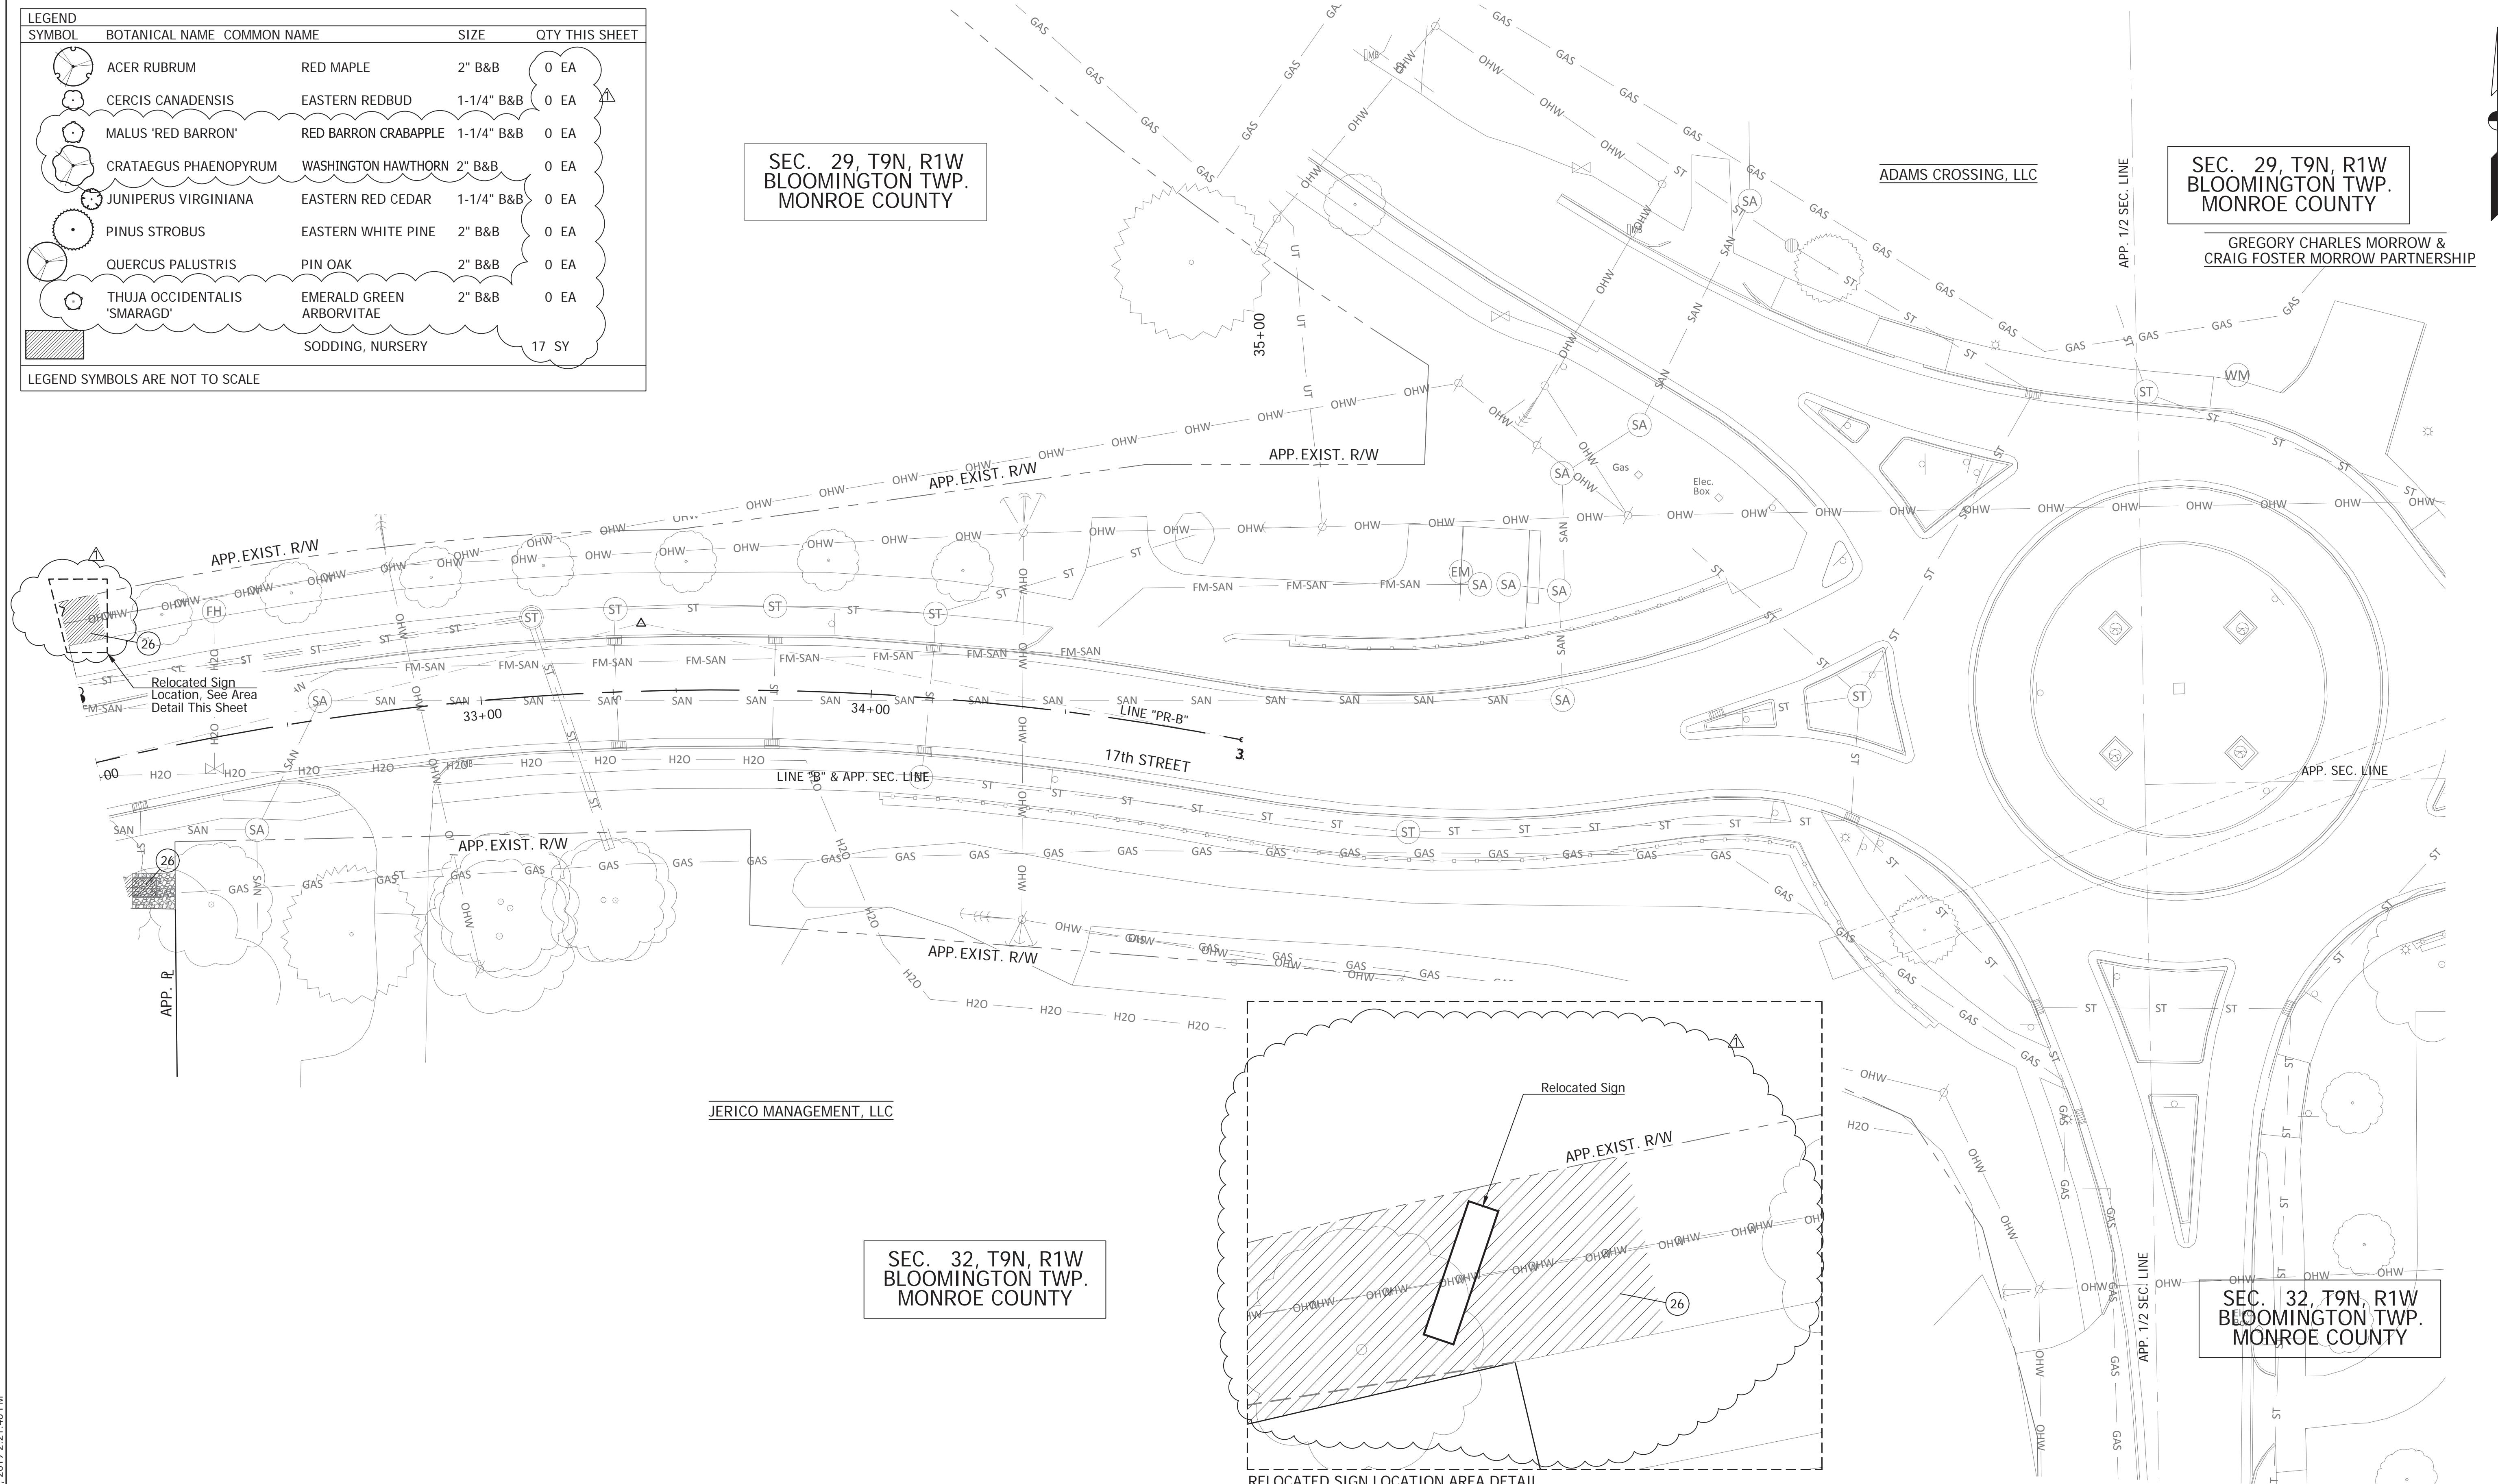

SEC. 32, T9N, R1W
BLOOMINGTON TWP.
MONROE COUNTY

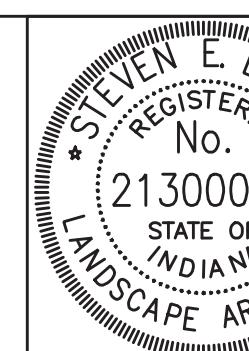




RECOMMENDED FOR APPROVAL		01-23-2019	
DESIGNED:	SEL	DRAWN:	JP
CHECKED:	SEL	CHECKED:	SEL

CITY OF BLOOMINGTON

LANDSCAPE DETAILS
STA 32+00 TO STA 35+00

SCALE	BRIDGE FILE
1"=20'	N/A
DESIGNATION	N/A
SURVEY BOOK	Sheets
N/A	59 of 100
CONTRACT	PROJECT
N/A	17TH STREET RECONSTRUCTION

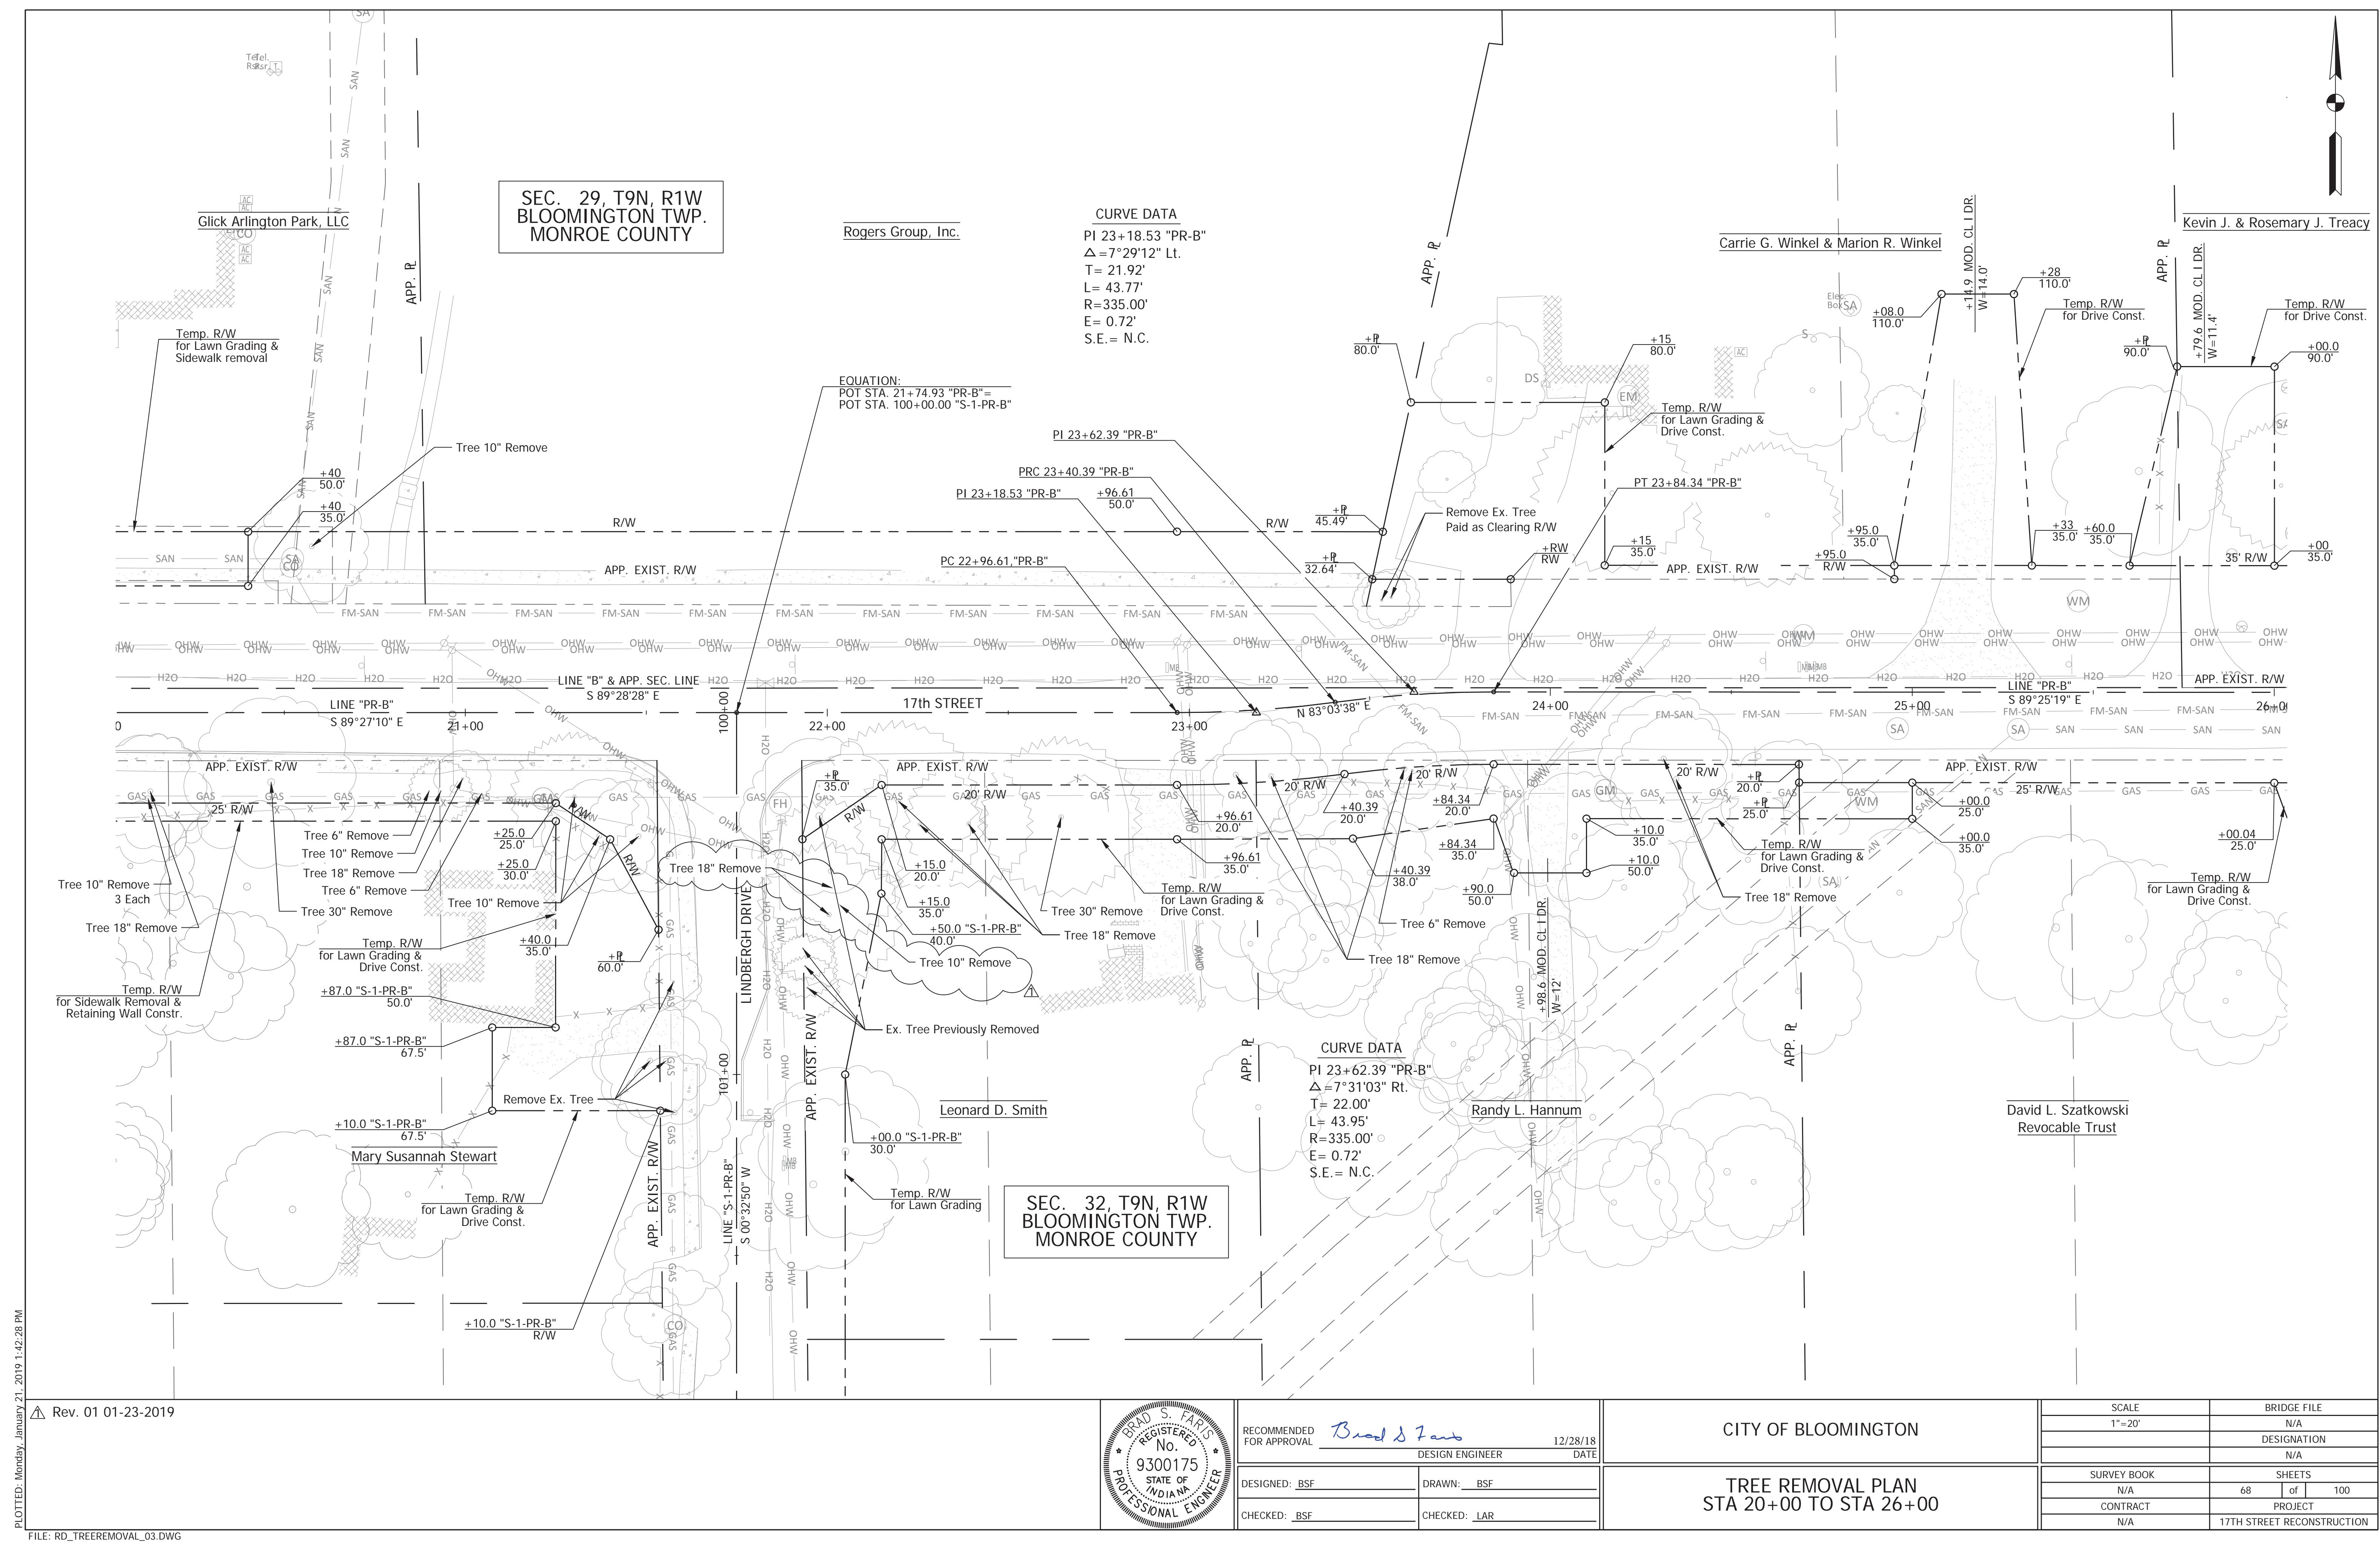

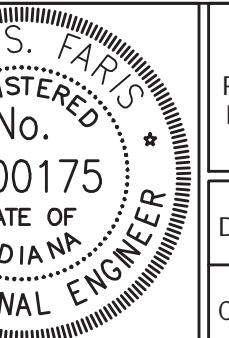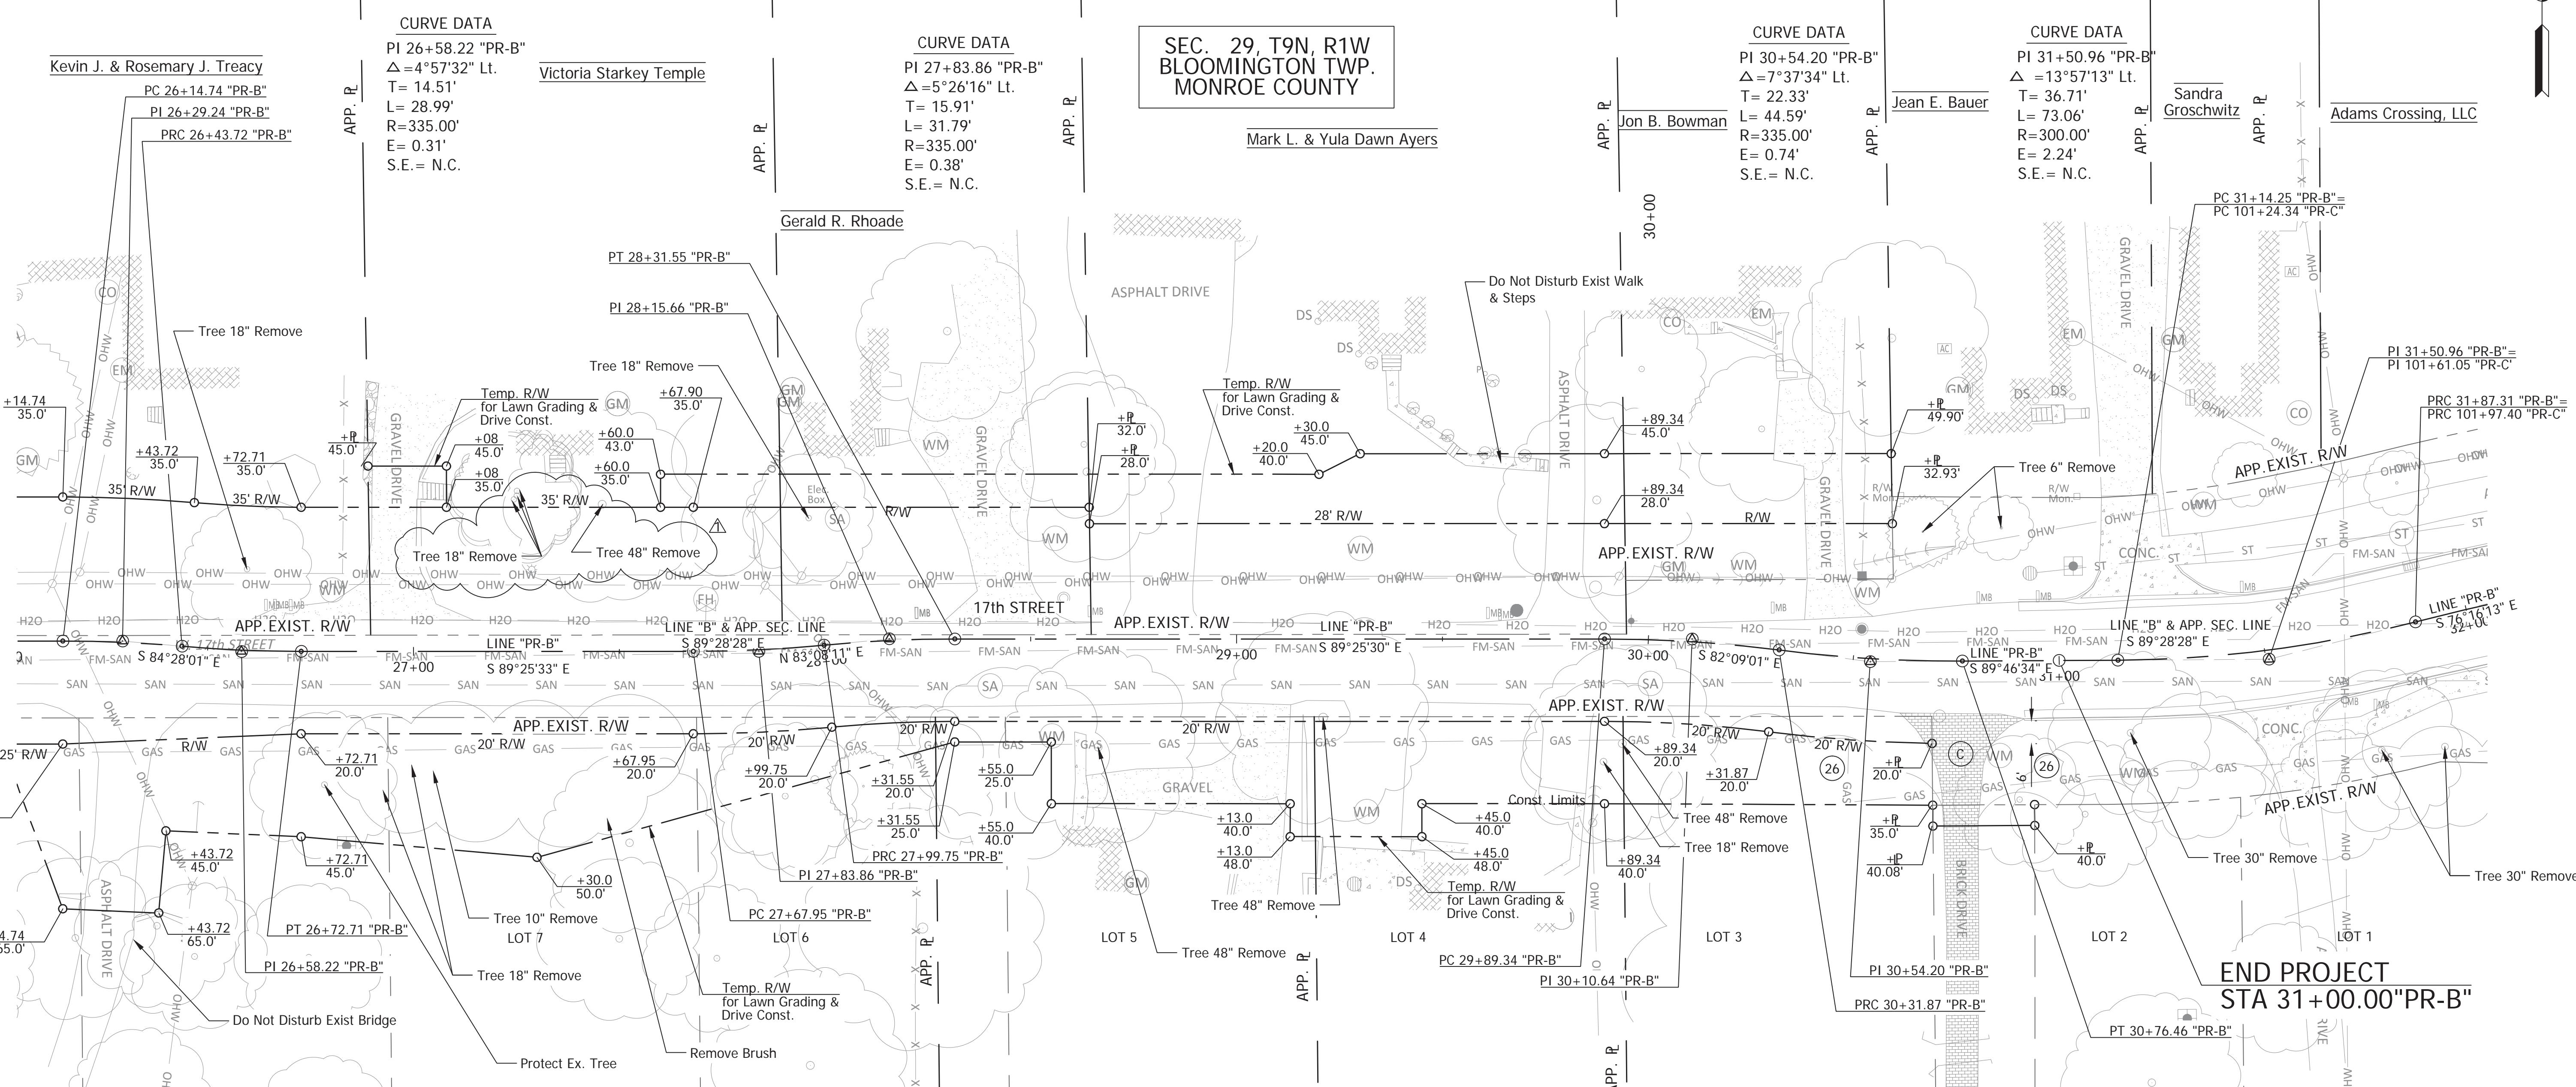

RECOMMENDED FOR APPROVAL

Brad S. Farns

DESIGN ENGINEER

12/28/18

DATE

DESIGNED: BSF

DRAWN: BSF

CHECKED: BSF

CHECKED: LAR

CITY OF BLOOMINGTON

TREE REMOVAL PLAN
STA 26+00 TO STA 32+00

SCALE	BRIDGE FILE
1"=20'	N/A
DESIGNATION	N/A
SURVEY BOOK	Sheets
N/A	69 of 100
CONTRACT	PROJECT
N/A	17TH STREET RECONSTRUCTION

