


PLANNING AND TRANSPORTATION DEPARTMENT

CITY OF BLOOMINGTON



MOORES PIKE AND CLARIZZ BOULEVARD INTERSECTION BLOOMINGTON, INDIANA

MAYOR, JOHN HAMILTON

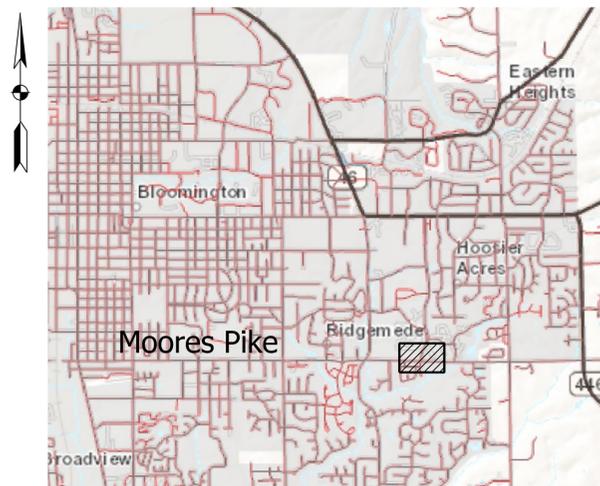

LOCATION MAP
MONROE COUNTY


 PROJECT AREA

The latest edition of the following Standards/Specifications shall be utilized in these plans: the Indiana Department of Transportation (INDOT) 2018 and the City of Bloomington Utilities for all materials, equipment, structures and installations.

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CMT
Engineers and Consultants
8790 PURDUE ROAD
INDIANAPOLIS, IN 46268-6128
PHONE: (317) 298-4500




PLANS PREPARED BY: CRAWFORD, MURPHY & TILLY (317) 298-4500
PHONE NUMBER
CERTIFIED BY: L.N. Batta 10/24/2018
DATE
APPROVED FOR LETTING: _____
CITY OF BLOOMINGTON DATE

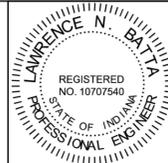	BRIDGE FILE	
	N/A	
	DESIGNATION	
	N/A	
SURVEY BOOK	SHEETS	
N/A	1	of 14
CONTRACT	PROJECT	
N/A	N/A	

QUANTITY SUMMARY

INDOT ITEM CODE	DESCRIPTION	UNIT	QUANTITY
105-06845	Construction Engineering	LSUM	1
107-09367	Inspection Hole, 3 Ft Deep or Less	EACH	2
110-01001	Mobilization and Demobilization	LSUM	1
201-52370	Clearing Right of Way	LSUM	1
202-02278	Curb, Concrete, Remove	LFT	312
202-02772	Casting, Remove	EACH	1
202-52710	Sidewalk, Concrete, Remove	SYS	88
203-02000	Excavation, Common	CYS	83
203-02070	Borrow	CYS	119
205-00000	Temporary Inlet Protection	EACH	3
205-06937	Temporary Silt Fence	LFT	363
301-07448	Compacted Aggregate No., 53 Base	TON	18
304-07490	HMA Patching, Type B	TON	27
401-10258	Joint adhesive, Surface	LFT	366
406-05520	Asphalt for Tack Coat	SYS	82
604-06070	Sidewalk, Concrete, 4 in.	SYS	110
604-08086	Curb Ramp, Concrete, 6 in.	SYS	60
604-12083	Detectable Warning Surfaces	SYS	9
605-06120	Curb, Concrete, 20 in.	LFT	218
605-06125	Curb, Concrete, Modified	LFT	145
621-06554	Mulched Seeding U	SYS	329
621-09867	Topsoil	CYS	58
720-44015	Casting, 2, Furnish and Adjust to Grade	EACH	1
720-45055	Inlet, M10	EACH	1
720-45615	Structure, Inlet, Reconstructed	LFT	1
801-06640	Construction Sign, A	EACH	6
801-06645	Construction Sign, B	EACH	4
801-06775	Maintaining Traffic	LSUM	1
802-05701	Sign, Post, Square Type 1 Reinforced Anchor Base	LFT	80
802-07060	Sign, Sheet, Relocate	EACH	2
802-09838	Sign, Sheet, with Legend, 0.080 in. Thickness	SFT	17
805-11799	Rectangular Rapid Flashing Beacon	EACH	2
808-03439	Transverse Marking, Thermoplastic, Crosswalk Line, White, 24 I	LFT	170
808-06368	Transverse Marking, Remove	LFT	24
808-06716	Line, Remove	LFT	20
808-75297	Transverse Marking, Thermoplastic, Stop Line, White, 24 IN	LFT	23

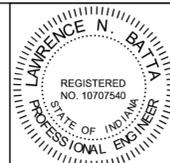



RECOMMENDED FOR APPROVAL *LNB Batta* 10/24/2018
 DESIGN ENGINEER DATE

DESIGNED: RCC 10/24/2018 DRAWN: RCC 10/24/2018
 CHECKED: LNB 10/24/2018 CHECKED: LNB 10/24/2018

INDIANA DEPARTMENT OF TRANSPORTATION

QUANTITY SUMMARY

SCALE	BRIDGE FILE
	N/A
	DESIGNATION
	N/A
SURVEY BOOK	SHEETS
N/A	3 of 14
CONTRACT	PROJECT
N/A	N/A

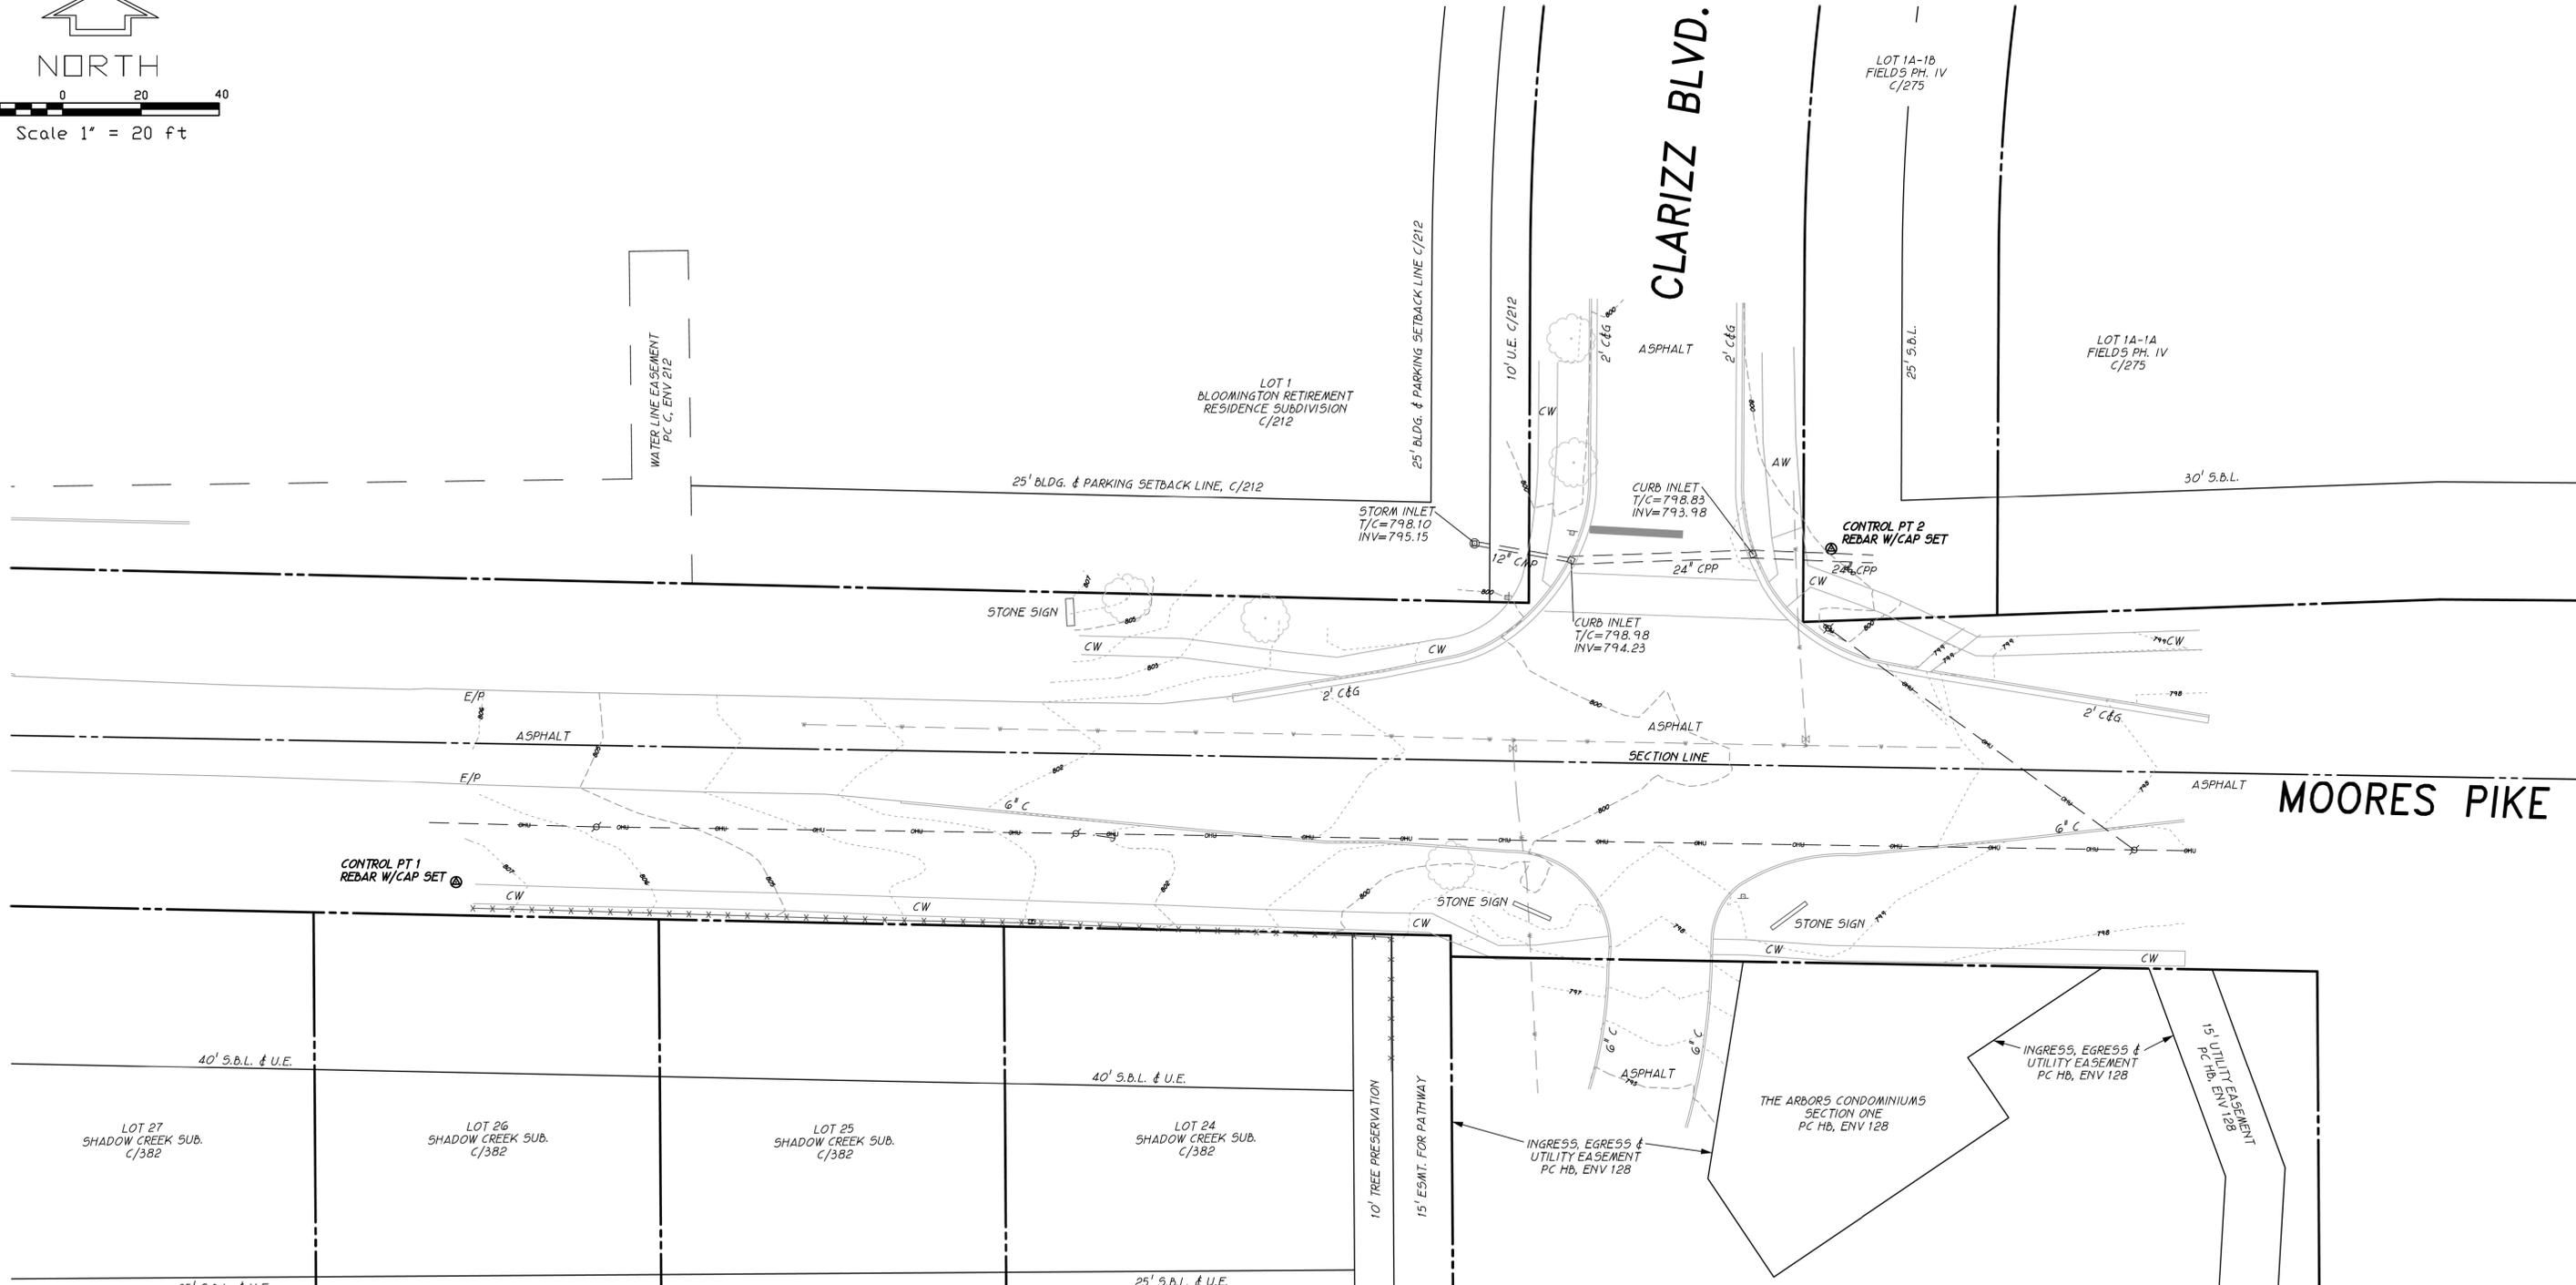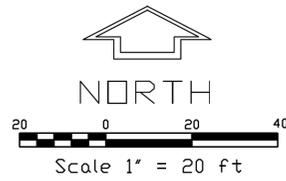

UTILITY CONTACT INFORMATION


<p>GAS VECTREN 205 S. MADISON ST. BLOOMINGTON, IN 47401 DOUG ANDERSON (812)330-4009</p> <p>TELEPHONE AT&T P.O. BOX 56 BLOOMINGTON, IN 47402 BRENT McCABE (812)334-4521</p>	<p>SEWER AND WATER CITY OF BLOOMINGTON UTILITIES 600 E. MILLER DR. BLOOMINGTON, IN 47402 NANCY AXSON (812)349-3689</p> <p>CABLE TELEVISION COMCAST 2450 SOUTH HENDERSON STREET BLOOMINGTON, IN 47404 SCOTT TEMPLETON (812)355-7822</p>	<p>ELECTRIC DUKE ENERGY 1619 W. DEFFENBAUGH ROAD KOKOMO, INDIANA 46902 JIM SHIELDS (317)375-2071</p> <p>UNDERGROUND UTILITY LOCATION INDIANA UNDERGROUND PLANT PROTECTION 1-(800)382-5544</p>
--	--	---

PROPERTY LINE	---	TELEPHONE RISER	○
EASEMENT LINE	- - - - -	ELECTRIC TRANSFORMER	□
FENCE	X - - - - X	STORM BASIN	⊠
OVERHEAD UTILITIES	- - OHU - - - -	WATER VALVE	⊞
OVERHEAD ELECTRIC LINE	- - E - - - -	SIGN	⊞
UNDERGROUND ELECTRIC LINE	- - UGE - - - -	AREA LIGHT	⊞
UNDERGROUND GAS LINE	- - GAS - - - -	SANITARY SEWER CLEAN OUT	⊞
UNDERGROUND TELEPHONE LINE	- - UGT - - - -	CABLE T.V. BOX	⊞
WATER LINE	- - W - - - -	GAS METER	⊞
SANITARY SEWER LINE	- - S - - - -	LANDSCAPE AREA	⊞
DEED RECORD BOOK AND PAGE	XXX/XXX	INGRESS AND EGRESS EASEMENT	⊞
5/8" REBAR WITH CAP SET	○ S	DRAINAGE AND UTILITY EASEMENT	⊞
MAG NAIL SET	○ MN	UTILITY POLE ANCHOR	⊞
RECORD	R	ANTENNA	⊞
MEASURED	M	MAIL BOX	⊞
RIGHT-OF-WAY	ROW	AIR CONDITIONING PAD	⊞
UTILITY POLE	⊞	CONCRETE WALK	CW
FIRE HYDRANT	⊞	ASPHALT WALK	AW
ELECTRIC METER	⊞	2' CONCRETE ROLL CURB	2'RC
WATER METER	⊞	2' CONCRETE CURB & GUTTER	2' C&G
REINFORCED CONCRETE PIPE	RCP	6" CONCRETE CURB	6" C
CORRUGATED PLASTIC PIPE	CPP	CORRUGATED METAL PIPE	CMP

SITE CONTROL
 1, N=1421723.785, E=3120336.526, ELEV=807.54
 2, N=1421808.569, E=3120687.256, ELEV=800.12
 3, N=1421605.646, E=3120668.620, ELEV=790.49
 SURVEY DATUM IS BASED ON INCORS NETWORK (INDIANA CONTINUOUSLY OPERATING REFERENCE STATION NETWORK) AND IS IN THE STATE PLANE COORDINATE SYSTEM. ELEVATION DATUM IS ALSO BASE ON THIS DATUM.


PREPARED BY BYNUM FANYO & ASSOCIATES INC. 528 N. WALNUT ST. BLOOMINGTON, IN. 47404

INDIANA DEPARTMENT OF TRANSPORTATION	SCALE	BRIDGE FILE
		N/A
LOCATION CONTROL ROUTE SURVEY		DESIGNATION
		N/A
	SURVEY BOOK	SHEETS
	N/A	4 of 14
	CONTRACT	PROJECT
	N/A	N/A

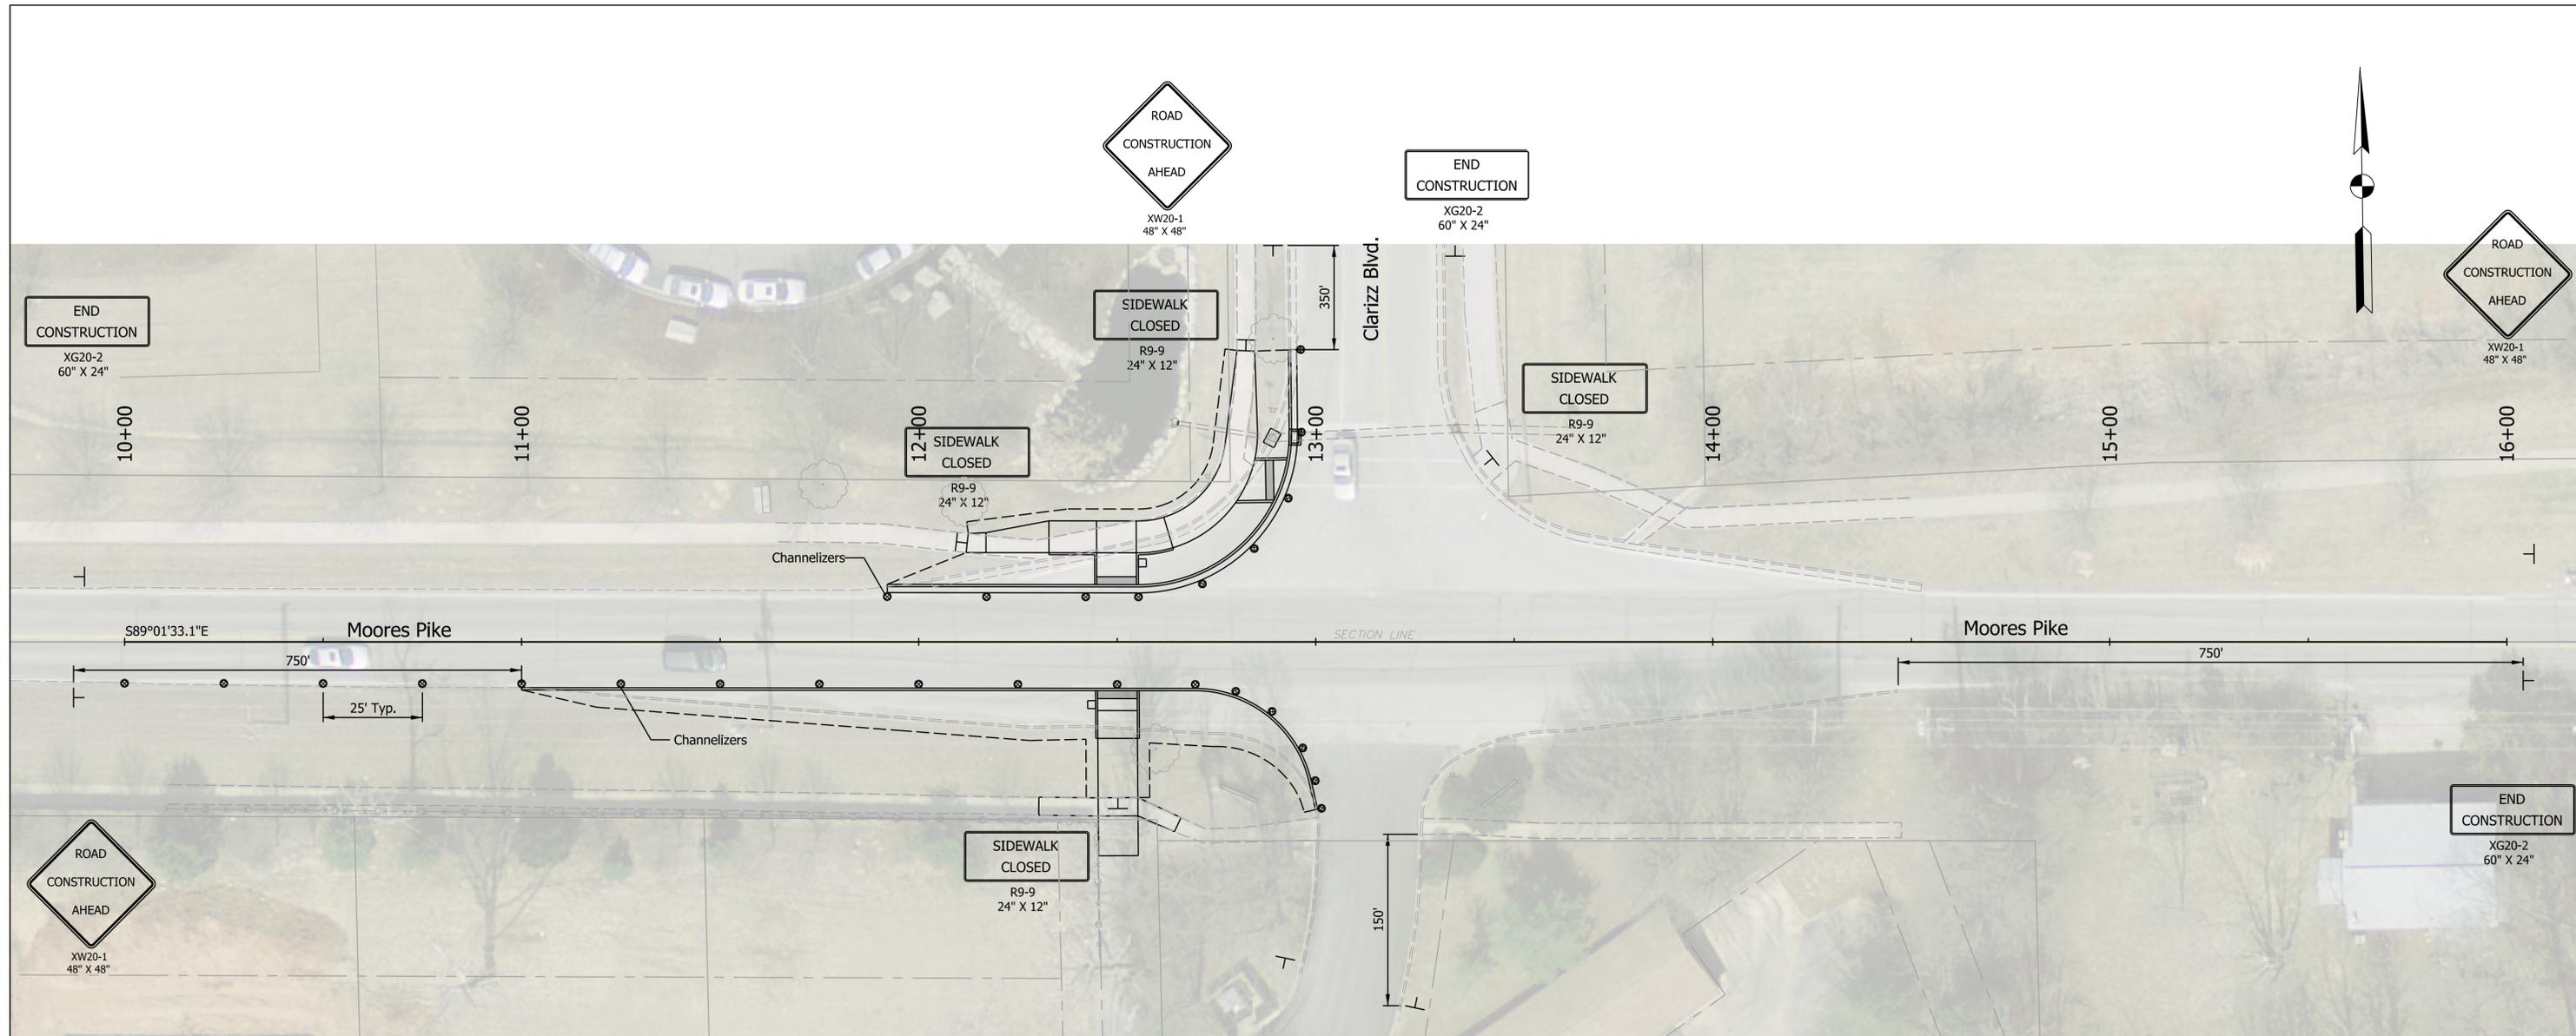

NOTES:



1. Contractor shall coordinate with adjacent construction projects.
2. Contractor shall be responsible for all required excavation protection and stabilization of existing facilities, existing and proposed utilities, building walls, retaining walls, existing and proposed foundations, slopes and any or all other elements within or adjacent to the public Right of Way that may potentially be affected by the excavation or construction procedures.
3. Contractor shall abide by the City of Bloomington Noise Ordinance (Chapter 14.09 of Bloomington, Indiana Code of Ordinances) which is in effect between 6:00 am and 10:00 pm on non-holidays and all day on Sunday and holidays unless allowed by exemption or special permit. Contractor shall be aware that the work is adjacent to residences and that the City of Bloomington and/or the Engineer may require that noise levels be reduced at 7:00 pm.
4. Contractor shall obtain right of way excavation permit for any work within the public right of way.
5. Locations of Construction Signs shall be adjusted per field conditions.

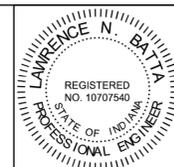

RECOMMENDED FOR APPROVAL	<i>L.N. Batta</i>	DESIGN ENGINEER	10/24/2018
DESIGNED:	RCC	10/24/2018	DRAWN: RCC 10/24/2018
CHECKED:	LNB	10/24/2018	CHECKED: LNB 10/24/2018

INDIANA DEPARTMENT OF TRANSPORTATION
MAINTENANCE OF TRAFFIC DETAILS

SCALE	BRIDGE FILE
1" = 20'	N/A
	DESIGNATION
	N/A
SURVEY BOOK	SHEETS
N/A	5 of 14
CONTRACT	PROJECT
N/A	N/A

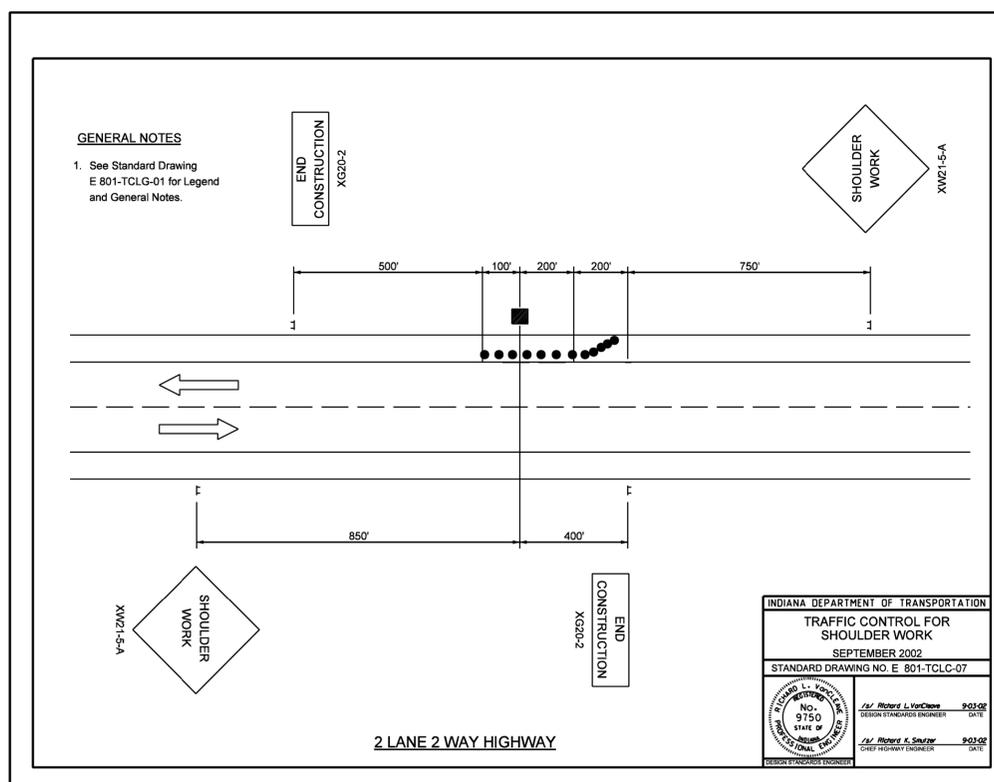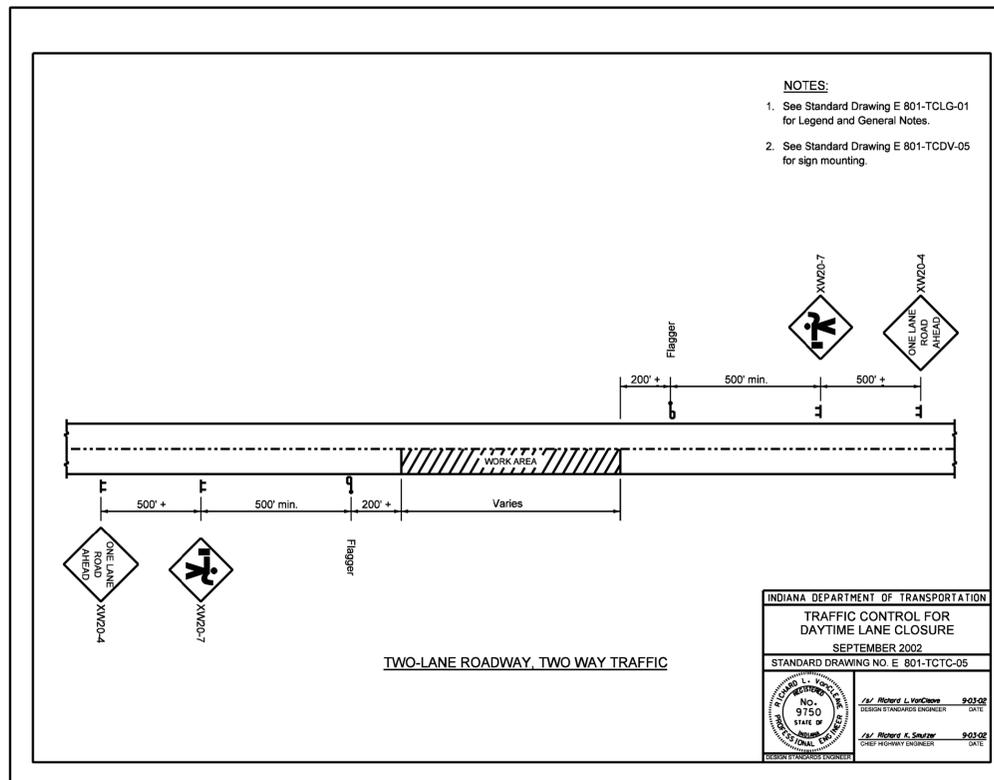

RECOMMENDED FOR APPROVAL _____ 10/24/2018
DESIGN ENGINEER DATE

DESIGNED: RCC 10/24/2018 DRAWN: RCC 10/24/2018
DATE DATE


CHECKED: LNB 10/24/2018 CHECKED: LNB 10/24/2018
DATE DATE

INDIANA DEPARTMENT
OF TRANSPORTATION

MAINTENANCE OF TRAFFIC

SCALE	BRIDGE FILE
	N/A
	DESIGNATION
	N/A
SURVEY BOOK	SHEETS
N/A	6 of 14
CONTRACT	PROJECT
N/A	N/A


Notes:
1. See Sheet 13 for details and pavement patching.

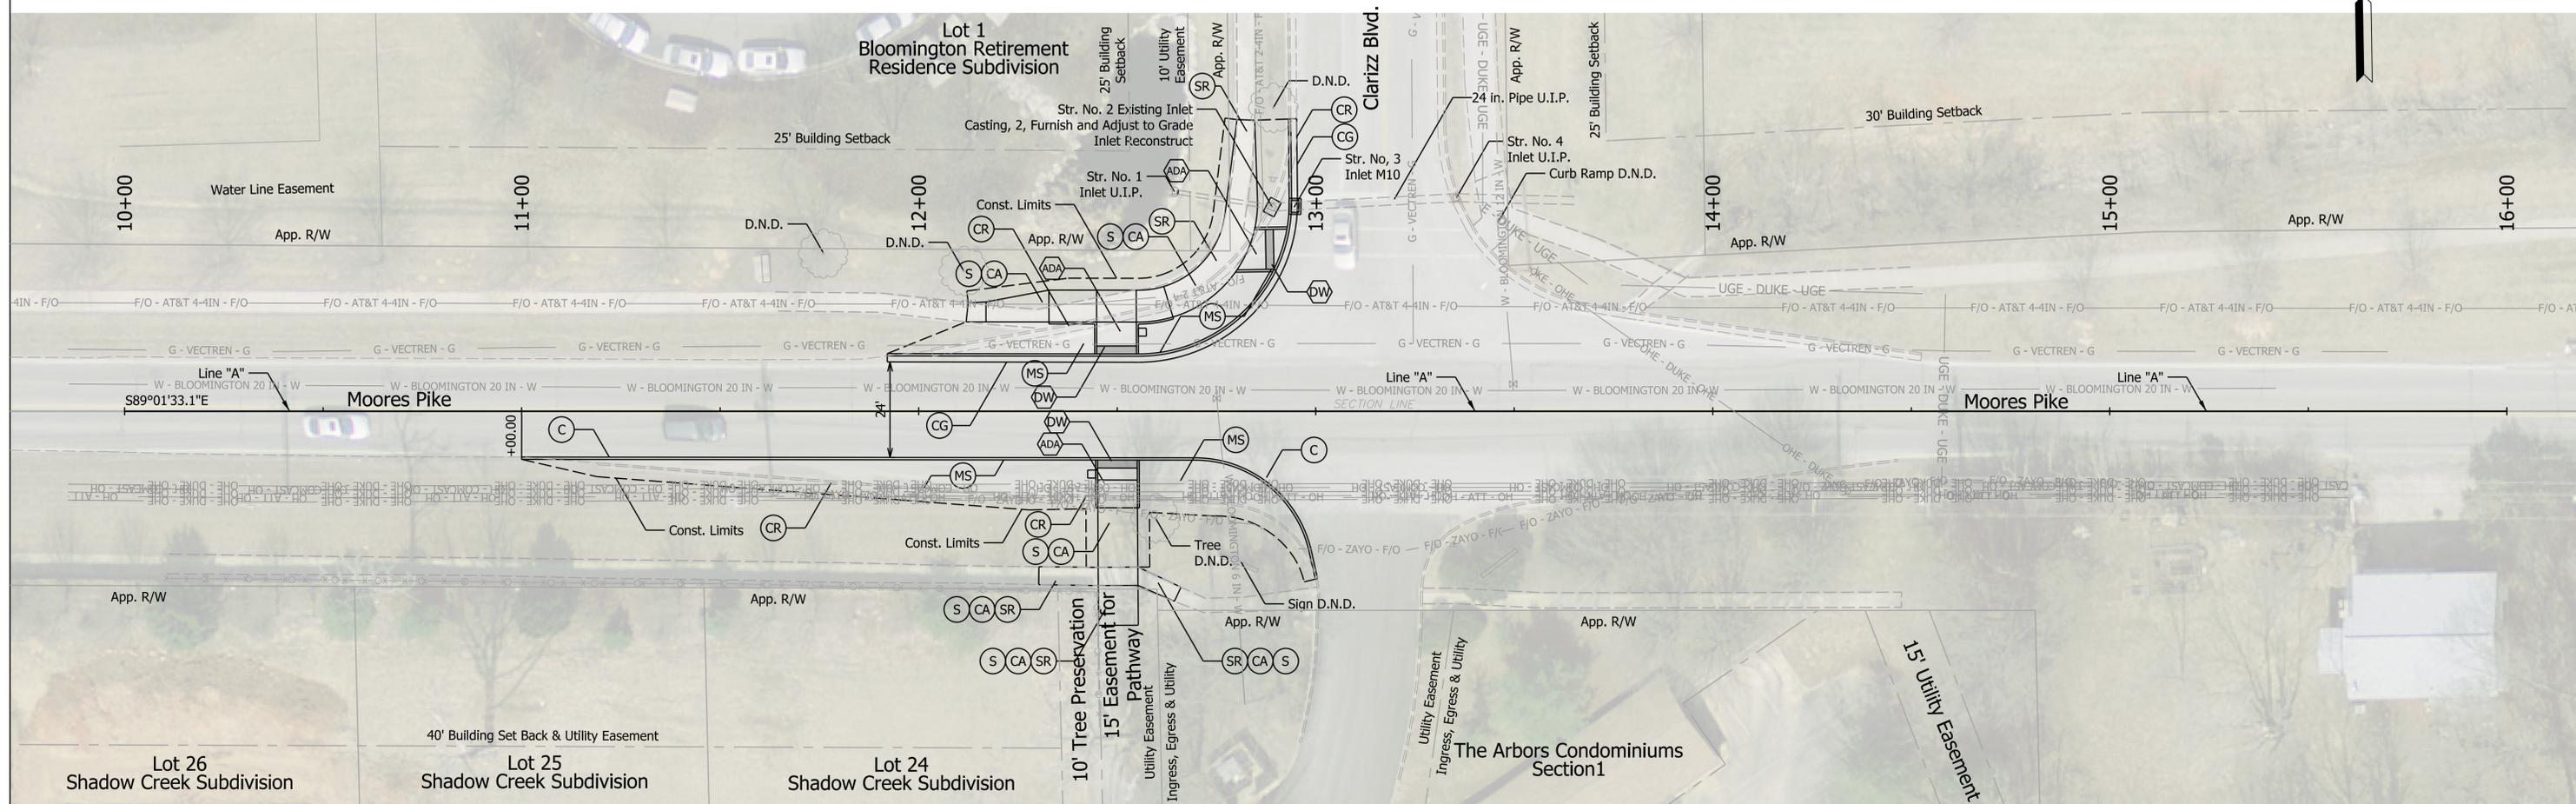

STRUCTURE DATA

STRUCTURE NUMBER	LOCATION				SIZE	DESCRIPTION		LENGTH	SKEW	FLOW LINE			TOP OF CASTING	PIPE END SECTION(S)	SERVICE LIFE	BACKFILL METHOD	STR. BACKFILL, TYPE 2'	CORE DRILLING	CONNECT TO STR.	REMARKS								
	STATION Line "A"	LEFT	RIGHT	CROSS		OFFSET	PIPE TYPE			MANHOLE, INLET, CATCH BASIN, OR SPECIALTY STRUCTURE	COVER	UP STREAM									DOWN STREAM	ELEV.	ELEV.	ELEV.	EA.	YRS.	CYS	EA.
1	12+64.48	X			55.15	12	Existing CMP	Existing			795.15	794.23	798.10					2	Do Not disturb									
2	12+89.06	X			51.28	24	Existing HDPE	Existing			794.23	794.20	799.58					3	Casting, 2, Furnish and Adjust to Grade, Reconstruct Inlet for casting placement									
3	12+94.78	X			51.46	24	Existing HDPE	Inlet M10			794.20	793.98	799.00					4										
4	13+35.37	X			53.65	24	Existing HDPE	Existing			793.98		799.00					Outfall	Do Not Disturb									

- (C) Curb, Concrete, 20 In.
- (CA) Compacted Aggregate No. 53, Base
- (CG) Curb And Gutter, A, Concrete.
- (CR) Curb Removal (All Types)
- (LI) Transverse Marking, Thermoplastic, Crosswalk Line, White, 24 In.
- (MS) Mulched Seeding With Special Topsoil
- (S) Sidewalk, Concrete, 4 In.
- (SB) Transverse Marking, Thermoplastic, Stop Line, White, 24 In.
- (SR) Sidewalk Removal (All Types)
- (YL) Transverse Marking, Thermoplastic, Yield Marking, White, 24 In.
- (ADA) Curb Ramp, Concrete (See ADA Ramp Details)
- (DW) Detectable Warning Surface, Brick With Truncated Domes (To Be Paid For by Contractor)
- D.N.D. Do Not Disturb
- U.I.P. Use In Place

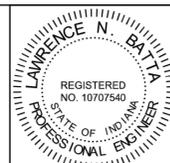


RECOMMENDED FOR APPROVAL: *L.N. Barta*
DESIGN ENGINEER 10/24/2018 DATE

DESIGNED: RCC 10/24/2018 DRAWN: RCC 10/24/2018
CHECKED: LNB 10/24/2018 CHECKED: LNB 10/24/2018

INDIANA DEPARTMENT OF TRANSPORTATION

CONSTRUCTION DETAILS


SCALE 1" = 20'	BRIDGE FILE N/A
	DESIGNATION N/A
SURVEY BOOK N/A	SHEETS 7 of 14
CONTRACT N/A	PROJECT N/A

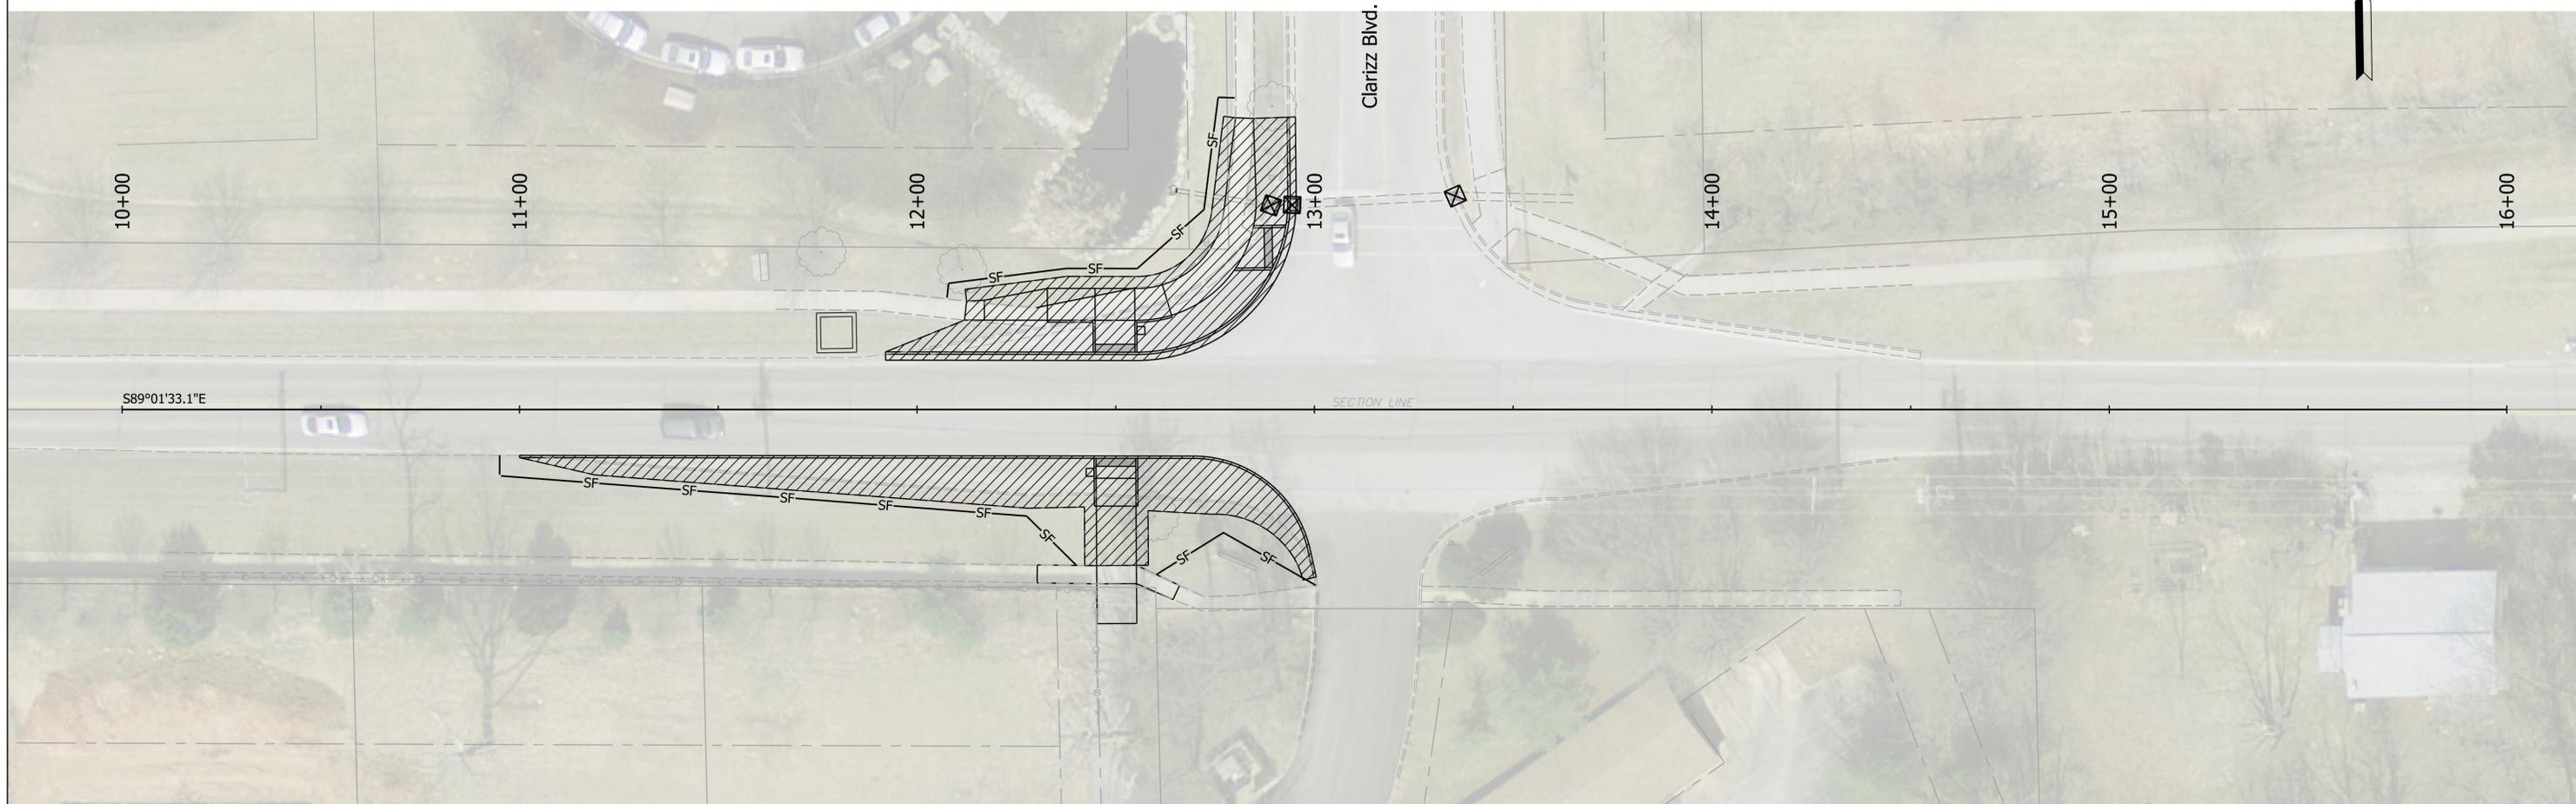

Notes:

1. The contractor shall implement the temporary erosion control plan to minimize erosion within the construction site and to limit sediment from leaving the construction site by utilizing proper temporary erosion control systems.
2. Certain erosion control facilities shall be installed by the contractor at the beginning of construction. Other items shall be installed by the Contractor as approved by the Engineer on a case by case basis depending on the Contractor's sequence of activities, the time of year and expected weather conditions.
3. All temporary erosion control measures shall be inspected daily with weekly submitted report or after a significant rainfall event for large sediment deposits and damage. Temporary erosion control measures shall be repaired as necessary and as directed by the Engineer.
4. The Contractor shall install permanent erosion control systems within a time specified herein and as directed by the Engineer. The Engineer will determine if any temporary erosion control systems listed in the plans can be deleted and if any additional temporary erosion control systems, which are not included in the plans, shall be addend.
5. Construction equipment shall be sorted and fueled only at designated locations as determined by the Engineer. All necessary measured shall be taken to contain any fuel or pollutant in accordance with EPA water quality regulations. Leaking equipment or supplies shall be immediately repaired or removed from the site.
6. Sediment collected during construction of various temporary erosion control systems shall be disposed of on the site on a regular basis as approved by the Engineer. No direct payment will be made.
7. Temporary erosion control systems shall be left in place with proper maintenance until permanent erosion control measures are in place and working properly.
8. The temporary erosion control systems shall be removed as approved by the engineer after use is no longer needed or system is no longer functioning. The cost of this removal shall be in the unit bid price for the various temporary erosion control items.
9. On-site and off-site solid stockpile and borrow areas shall be protected from erosion and sedimentation through the implementation of best management practices. Stockpile and borrow area locations shall be permitted in accordance with the permit requirements.
10. Temporary seeding shall be installed where additional work is not scheduled for at least seven (7) calendar days.
11. Temporary erosion control measures shall be installed in conjunction with Maintenance of Traffic - construction staging.
12. Concrete washouts shall be in a contained system per the Monroe County Soil and Water Conservation District. Washouts shall not be performed directly onto the ground.

- SF- Temporary Silt Fence
- ☒ Temporary Inlet Protection
- D.N.D. Do Not Disturb
- U.I.P. Use In Place
- Concrete Washout
- Construction Area

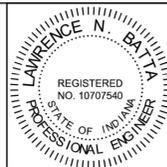

RECOMMENDED FOR APPROVAL	<i>L.N.B.</i>	DESIGN ENGINEER	10/24/2018
DESIGNED:	RCC	10/24/2018	DRAWN: RCC 10/24/2018
CHECKED:	LNB	10/24/2018	CHECKED: LNB 10/24/2018

INDIANA DEPARTMENT OF TRANSPORTATION	
EROSION CONTROL DETAILS	

SCALE	BRIDGE FILE
1" = 20'	N/A
	DESIGNATION
	N/A
SURVEY BOOK	SHEETS
N/A	8 of 14
CONTRACT	PROJECT
N/A	N/A

12+00

13+00

Moore's Pike



801.44
Exist.

800.80
Exist.

800.63
Exist.

+69.67, 11.69' Rt.
800.37, Exist.

800.20
Exist.

800.72

800.16

800.57

800.01

800.00
Exist.

799.49
Exist.

799.00
Exist.

+00.47, 42.05' Lt.
798.53, Exist.

800.14
Exist.

799.42

799.27

Sta. 12+69.64
41.69' Lt.

R = 30.00'
∠ = 77°13'12.89"
L = 40.43'

800.00
Exist.

799.35

799.20

798.00
Exist.


797.94
Exist.

798.78
Exist.

798.27
Exist.

Area	Length (LFT)	Width (LFT)
(A)	5.0'	10.0'
(B)	7.0'	10.0'
(C)	14.9'	10.0'
(D)	10.0'	4.6'

Arbors Ln.

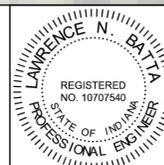

RECOMMENDED FOR APPROVAL *L.N. Batta*
DESIGN ENGINEER 10/24/2018 DATE


DESIGNED: RCC 10/24/2018 DRAWN: RCC 10/24/2018

CHECKED: LNB 10/24/2018 CHECKED: LNB 10/24/2018


INDIANA DEPARTMENT OF TRANSPORTATION

ADA RAMP DETAIL

SCALE 1" = 5'	BRIDGE FILE N/A
	DESIGNATION N/A
SURVEY BOOK N/A	SHEETS 10 of 14
CONTRACT N/A	PROJECT N/A

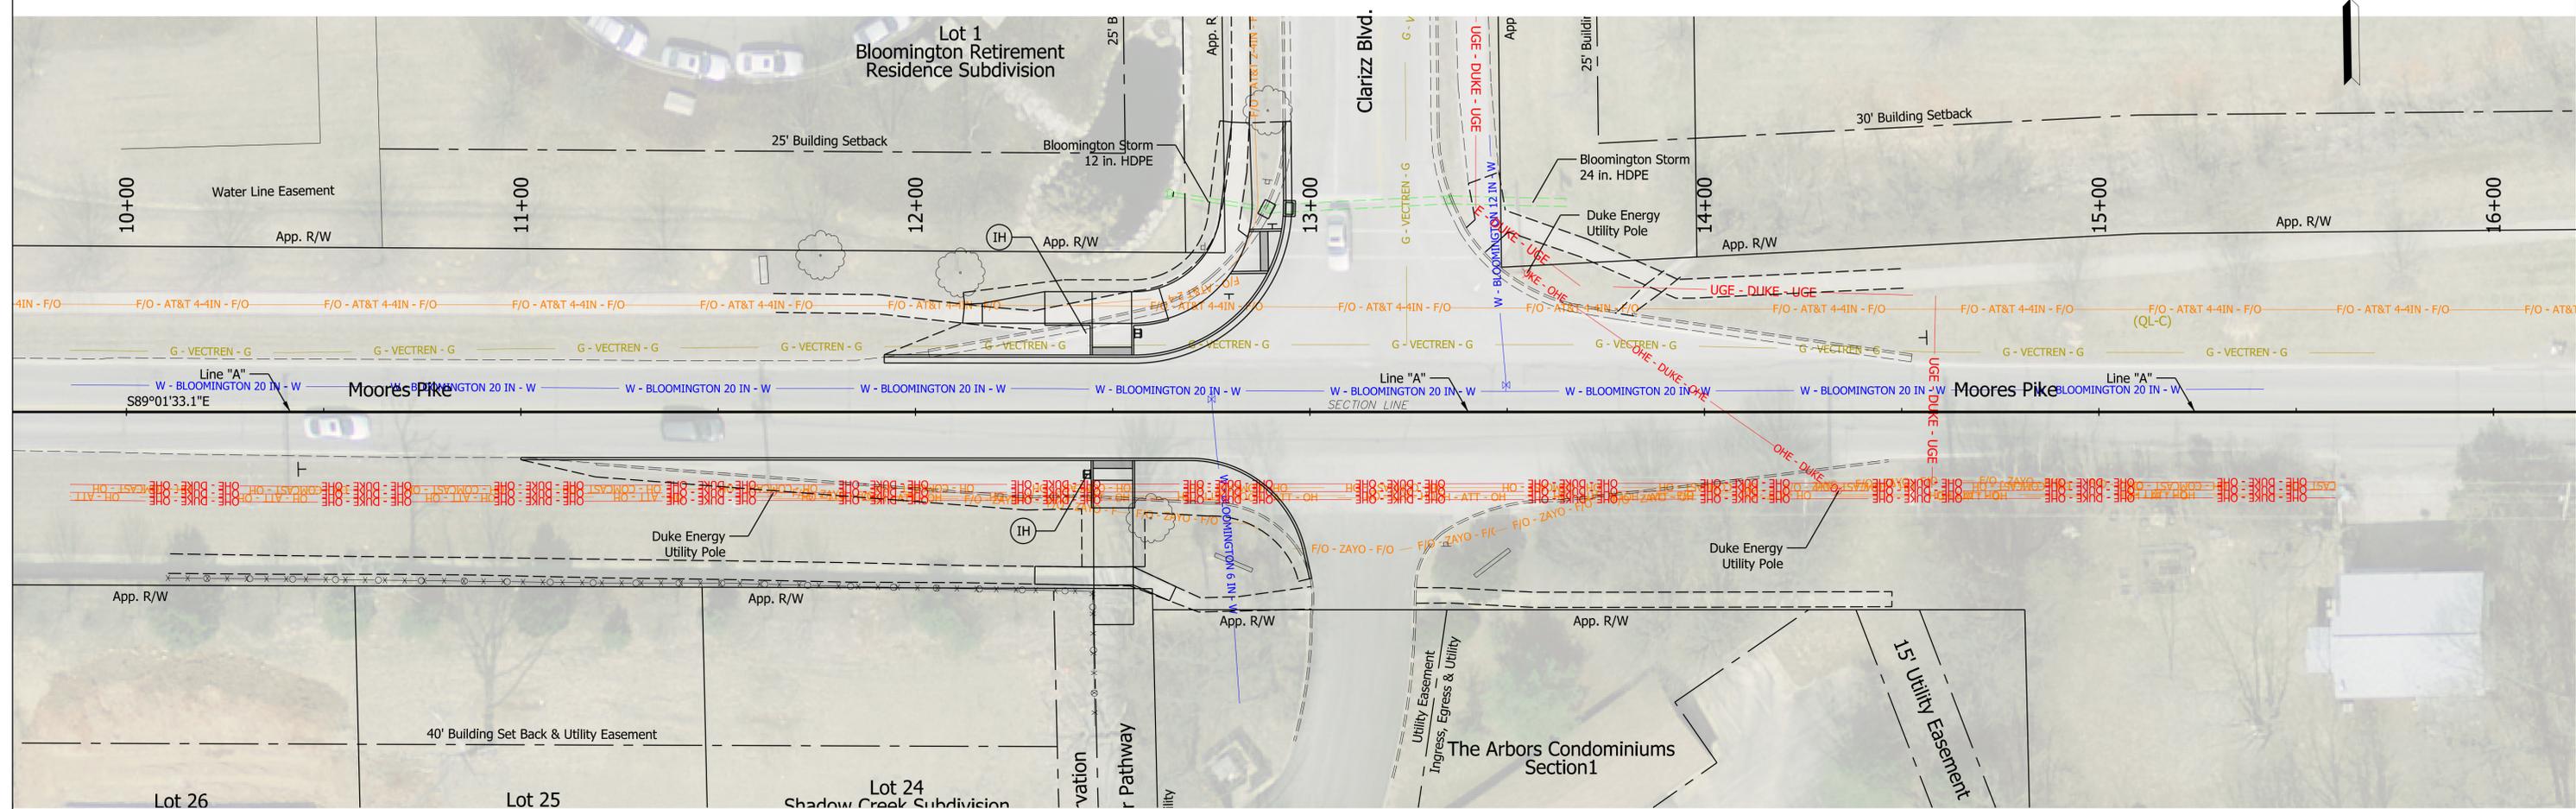

(IH) Inspection Hole, Deeper than 3 Ft.

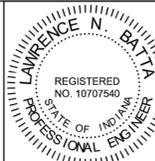


RECOMMENDED FOR APPROVAL: *LNB Batta*
 DESIGN ENGINEER \$SIG_DT\$ DATE
 DESIGNED: RCC 10/24/2018 DRAWN: NGM 10/24/2018
 CHECKED: LNB \$DESCKBY_DATES\$ CHECKED: LNB 10/24/2018

INDIANA DEPARTMENT OF TRANSPORTATION


UTILITY DETAILS

SCALE 1" = 20'	BRIDGE FILE
	DESIGNATION
SURVEY BOOK	SHEETS
CONTRACT N/A	12 of 14 PROJECT N/A


- ① Where sidewalk is constructed immediately adjacent to non-monolithic curb, the surface of the sidewalk shall be constructed 1/2" higher than the top of the curb.
- ② Patching to match existing roadsurface shall be with materials and thicknesses matching the adjacent pavement. (conc. or asphalt) this is a pay item. The cost of which is to be paid for in the bid item HMA Patching Type, B.
- ③ Patching of paved areas behind curbs or sidewalks (ie. existing parking areas, driveways, etc.) shall be with materials and thicknesses matching said adjoining paved area. This is a non-pay item. The cost of which is to be included in the cost of curb and/or sidewalk.

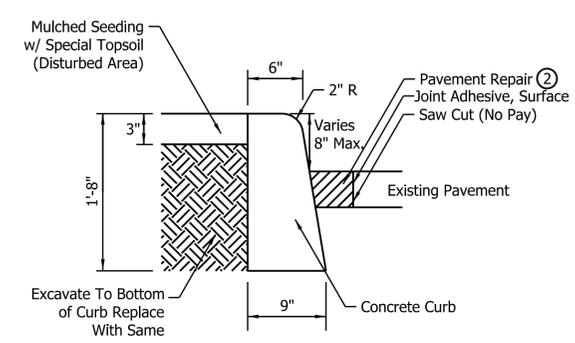


C
Curb, Concrete, 20 In.
 N.T.S.

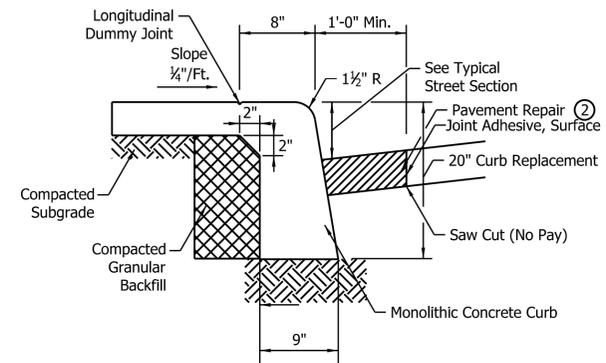

MC
Curb, Monolithic Conc., 20 In.
 N.T.S.

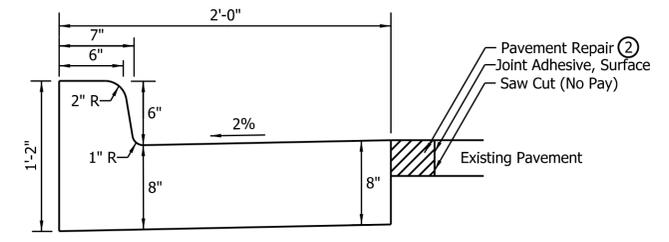

CG
Curb And Gutter
Concrete, Modified
 N.T.S.

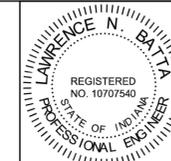




RECOMMENDED FOR APPROVAL	<i>L.N.B.</i>	DESIGN ENGINEER	10/24/2018	DATE
DESIGNED:	RCC	10/24/2018	DRAWN:	RCC 10/24/2018
CHECKED:	LNB	10/24/2018	CHECKED:	LNB 10/24/2018

INDIANA DEPARTMENT OF TRANSPORTATION

MISCELLANEOUS DETAILS


SCALE	BRIDGE FILE
N.T.S.	N/A
	DESIGNATION
	N/A
SURVEY BOOK	SHEETS
N/A	13 of 14
CONTRACT	PROJECT
N/A	N/A

- NOTES:
- Warning signs shall have black legend and border on a yellow background.
 - Push button shall be APS Polara.

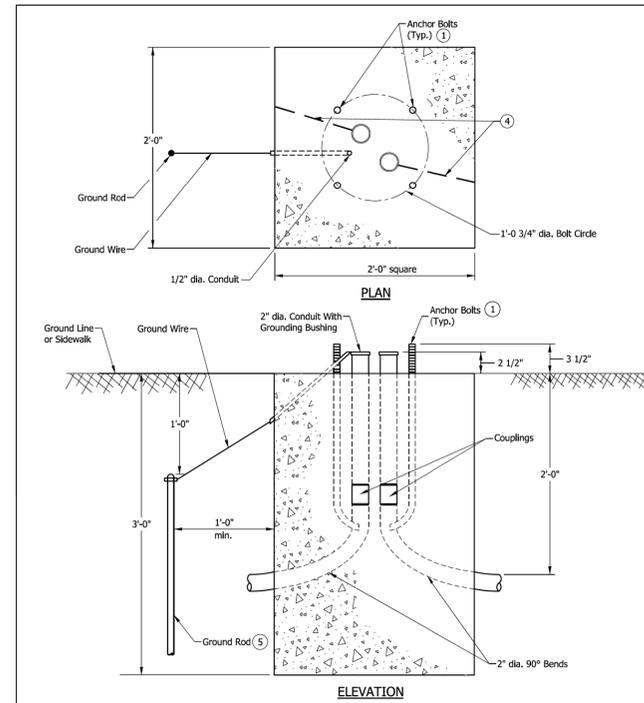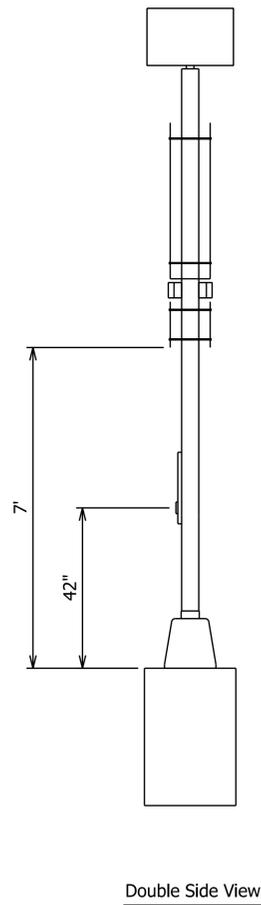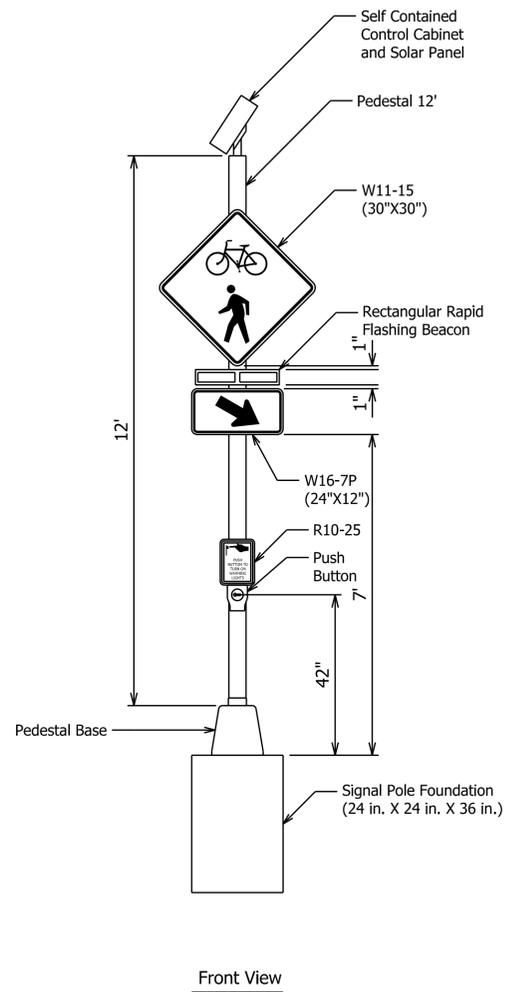


- GENERAL NOTES:
- See Standard Drawing E 805-SGPB-01 for anchor bolt details.
 - A minimum of two 2-in. dia. conduit inlets shall be installed for each foundation.
 - Conduit inlets not used shall be capped below grade. More inlets shall be installed as required on plans.
 - Make a permanent line on top of the concrete foundation indicating the direction of the 2-in. conduits' exit.
 - The ground rod has length 8 ft.
 - The signal pole foundation, 24 in. x 24 in. x 36 in. is also known as a type A foundation.

INDIANA DEPARTMENT OF TRANSPORTATION	
SIGNAL POLE FOUNDATION, 24 IN. X 24 IN. X 36 IN.	
SEPTEMBER 2013	
STANDARD DRAWING NO. E 805-SGCF-03	
	/s/ Alfredo B. Hanzca DESIGN STANDARDS ENGINEER DATE 02/27/13
	/s/ Mark A. Miller CHIEF ENGINEER DATE 03/27/13

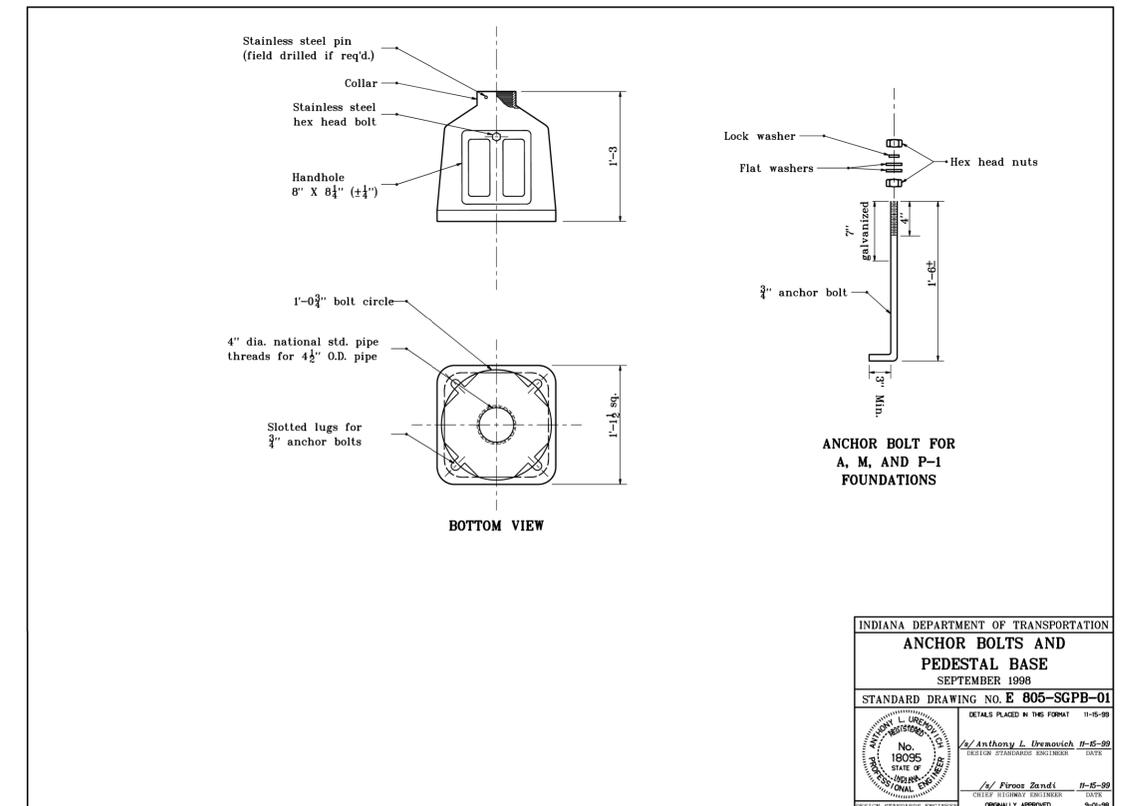

INDIANA DEPARTMENT OF TRANSPORTATION	
ANCHOR BOLTS AND PEDESTAL BASE	
SEPTEMBER 1998	
STANDARD DRAWING NO. E 805-SGPB-01	
	/s/ Anthony L. Dremovich DESIGN STANDARDS ENGINEER DATE 11-15-99
	/s/ Finoo Zandi CHIEF ENGINEER DATE 9-15-98

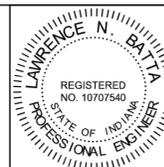

RECOMMENDED FOR APPROVAL	<i>L.N. Batta</i>	DESIGN ENGINEER	10/24/2018
DESIGNED:	RCC	10/24/2018	DRAWN: RCC 10/24/2018
CHECKED:	LNB	10/24/2018	CHECKED: LNB 10/24/2018

INDIANA DEPARTMENT OF TRANSPORTATION
RECTANGULAR RAPID FLASHING BEACON DETAILS

SCALE	BRIDGE FILE
	N/A
	DESIGNATION
	N/A
SURVEY BOOK	SHEETS
N/A	14 of 14
CONTRACT	PROJECT
N/A	N/A